# PROPOSED DEVELOPMENT NEXTDC S3 DATA CENTRE SECTION 4.55

LOT 6, 219-247 PACIFIC HIGHWAY ARTARMON, NSW. 2046

SHEET NUMBER	SHEET NAME	ISSUE DESCRIPTION	REV	DAT
DA000	COVER SHEET	SECTION 4.55 - ISSUE FOR APPROVAL	F	20.03.2020
DA003	SITE ANALYSIS PLAN	ISSUE FOR COMMENT	D	28.02.2020
DA005	SITE PLAN	SECTION 4.55 - ISSUE FOR APPROVAL	E	20.03.2020
DA006	CALCULATIONS	SECTION 4.55 - ISSUE FOR APPROVAL	E	20.03.2020
DA098	STAGING PLAN	ISSUE FOR DA	С	07.12.2018
DA099	BASEMENT PLAN	SECTION 4.55 - ISSUE FOR APPROVAL	0	20.03.2020
DA100	LEVEL 1 PLAN	SECTION 4.55 - ISSUE FOR APPROVAL	N	20.03.2020
DA101	LEVEL 2 PLAN	SECTION 4.55 - ISSUE FOR APPROVAL	M	20.03.2020
ÐA102≺	LEVEL 3 PLAN	SECTION 4.55 - ISSUE FOR APPROVAL	N	20.03.2020
DA103	LEVEL 4 PLAN	SECTION 4.55 - ISSUE FOR APPROVAL	M	20.03.2020
DA104	LEVEL 5 PLAN	SECTION 4.55 - ISSUE FOR APPROVAL	K	20.03.2020
DA105	LEVEL 6 PLAN	SECTION 4.55 - ISSUE FOR APPROVAL	K	20.03.2020
DA106	LEVEL 7 PLAN	SECTION 4.55 - ISSUE FOR APPROVAL	K	20.03.2020
DA107	LEVEL 8 PLAN	SECTION 4.55 - ISSUE FOR APPROVAL	K	20.03.2020
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DA200	NORTH ELEVATION (BROADCAST WAY)	SECTION 4.55 - ISSUE FOR APPROVAL	E	20.03.2020
DA201	EAST ELEVATION	SECTION 4.55 - ISSUE FOR APPROVAL	E	20.03.2020
DA202	SOUTH ELEVATION (PACIFIC HIGHWAY)	SECTION 4.55 - ISSUE FOR APPROVAL	E	20.03.2020
DA203	WEST ELEVATION (CAMPBELL STREET)	SECTION 4.55 - ISSUE FOR APPROVAL	E	20.03.2020
DA250	SECTION 1	SECTION 4.55 - ISSUE FOR APPROVAL	Н	20.03.2020
DA251	SECTION 2	SECTION 4.55 - ISSUE FOR APPROVAL	Н	20.03.2020
DA252	SECTION 3	SECTION 4.55 - ISSUE FOR APPROVAL	Н	20.03.2020
DA254	SECTION 4	SECTION 4.55 - ISSUE FOR APPROVAL	F	20.03.2020
DA601	PHOTOMONTAGE 01	SECTION 4.55 - ISSUE FOR APPROVAL	D	20.03.2020
DA602	PHOTOMONTAGE 02	SECTION 4.55 - ISSUE FOR APPROVAL	D	20.03.2020
DA603	PHOTOMONTAGE 03	SECTION 4.55 - ISSUE FOR APPROVAL	С	20.03.2020
DA604	PHOTOMONTAGE 04	SECTION 4.55 - ISSUE FOR APPROVAL	D	20.03.2020
DA610	SHADOW STUDY-COMPLIANT SCHEME	ISSUE FOR PRE-DA	В	21.09.2018
DA611	SHADOW STUDY- PROPOSED SCHEME	AMENDED ISSUE FOR DA	С	12.12.2018
DA612	SHADOW STUDY-DETAILED 3D	AMENDED ISSUE FOR DA	С	12.12.2018
DA613	SHADOW STUDY-IMPACT ON CENTRAL PARKLAND	ISSUE FOR INFORMATION	С	17.12.2018





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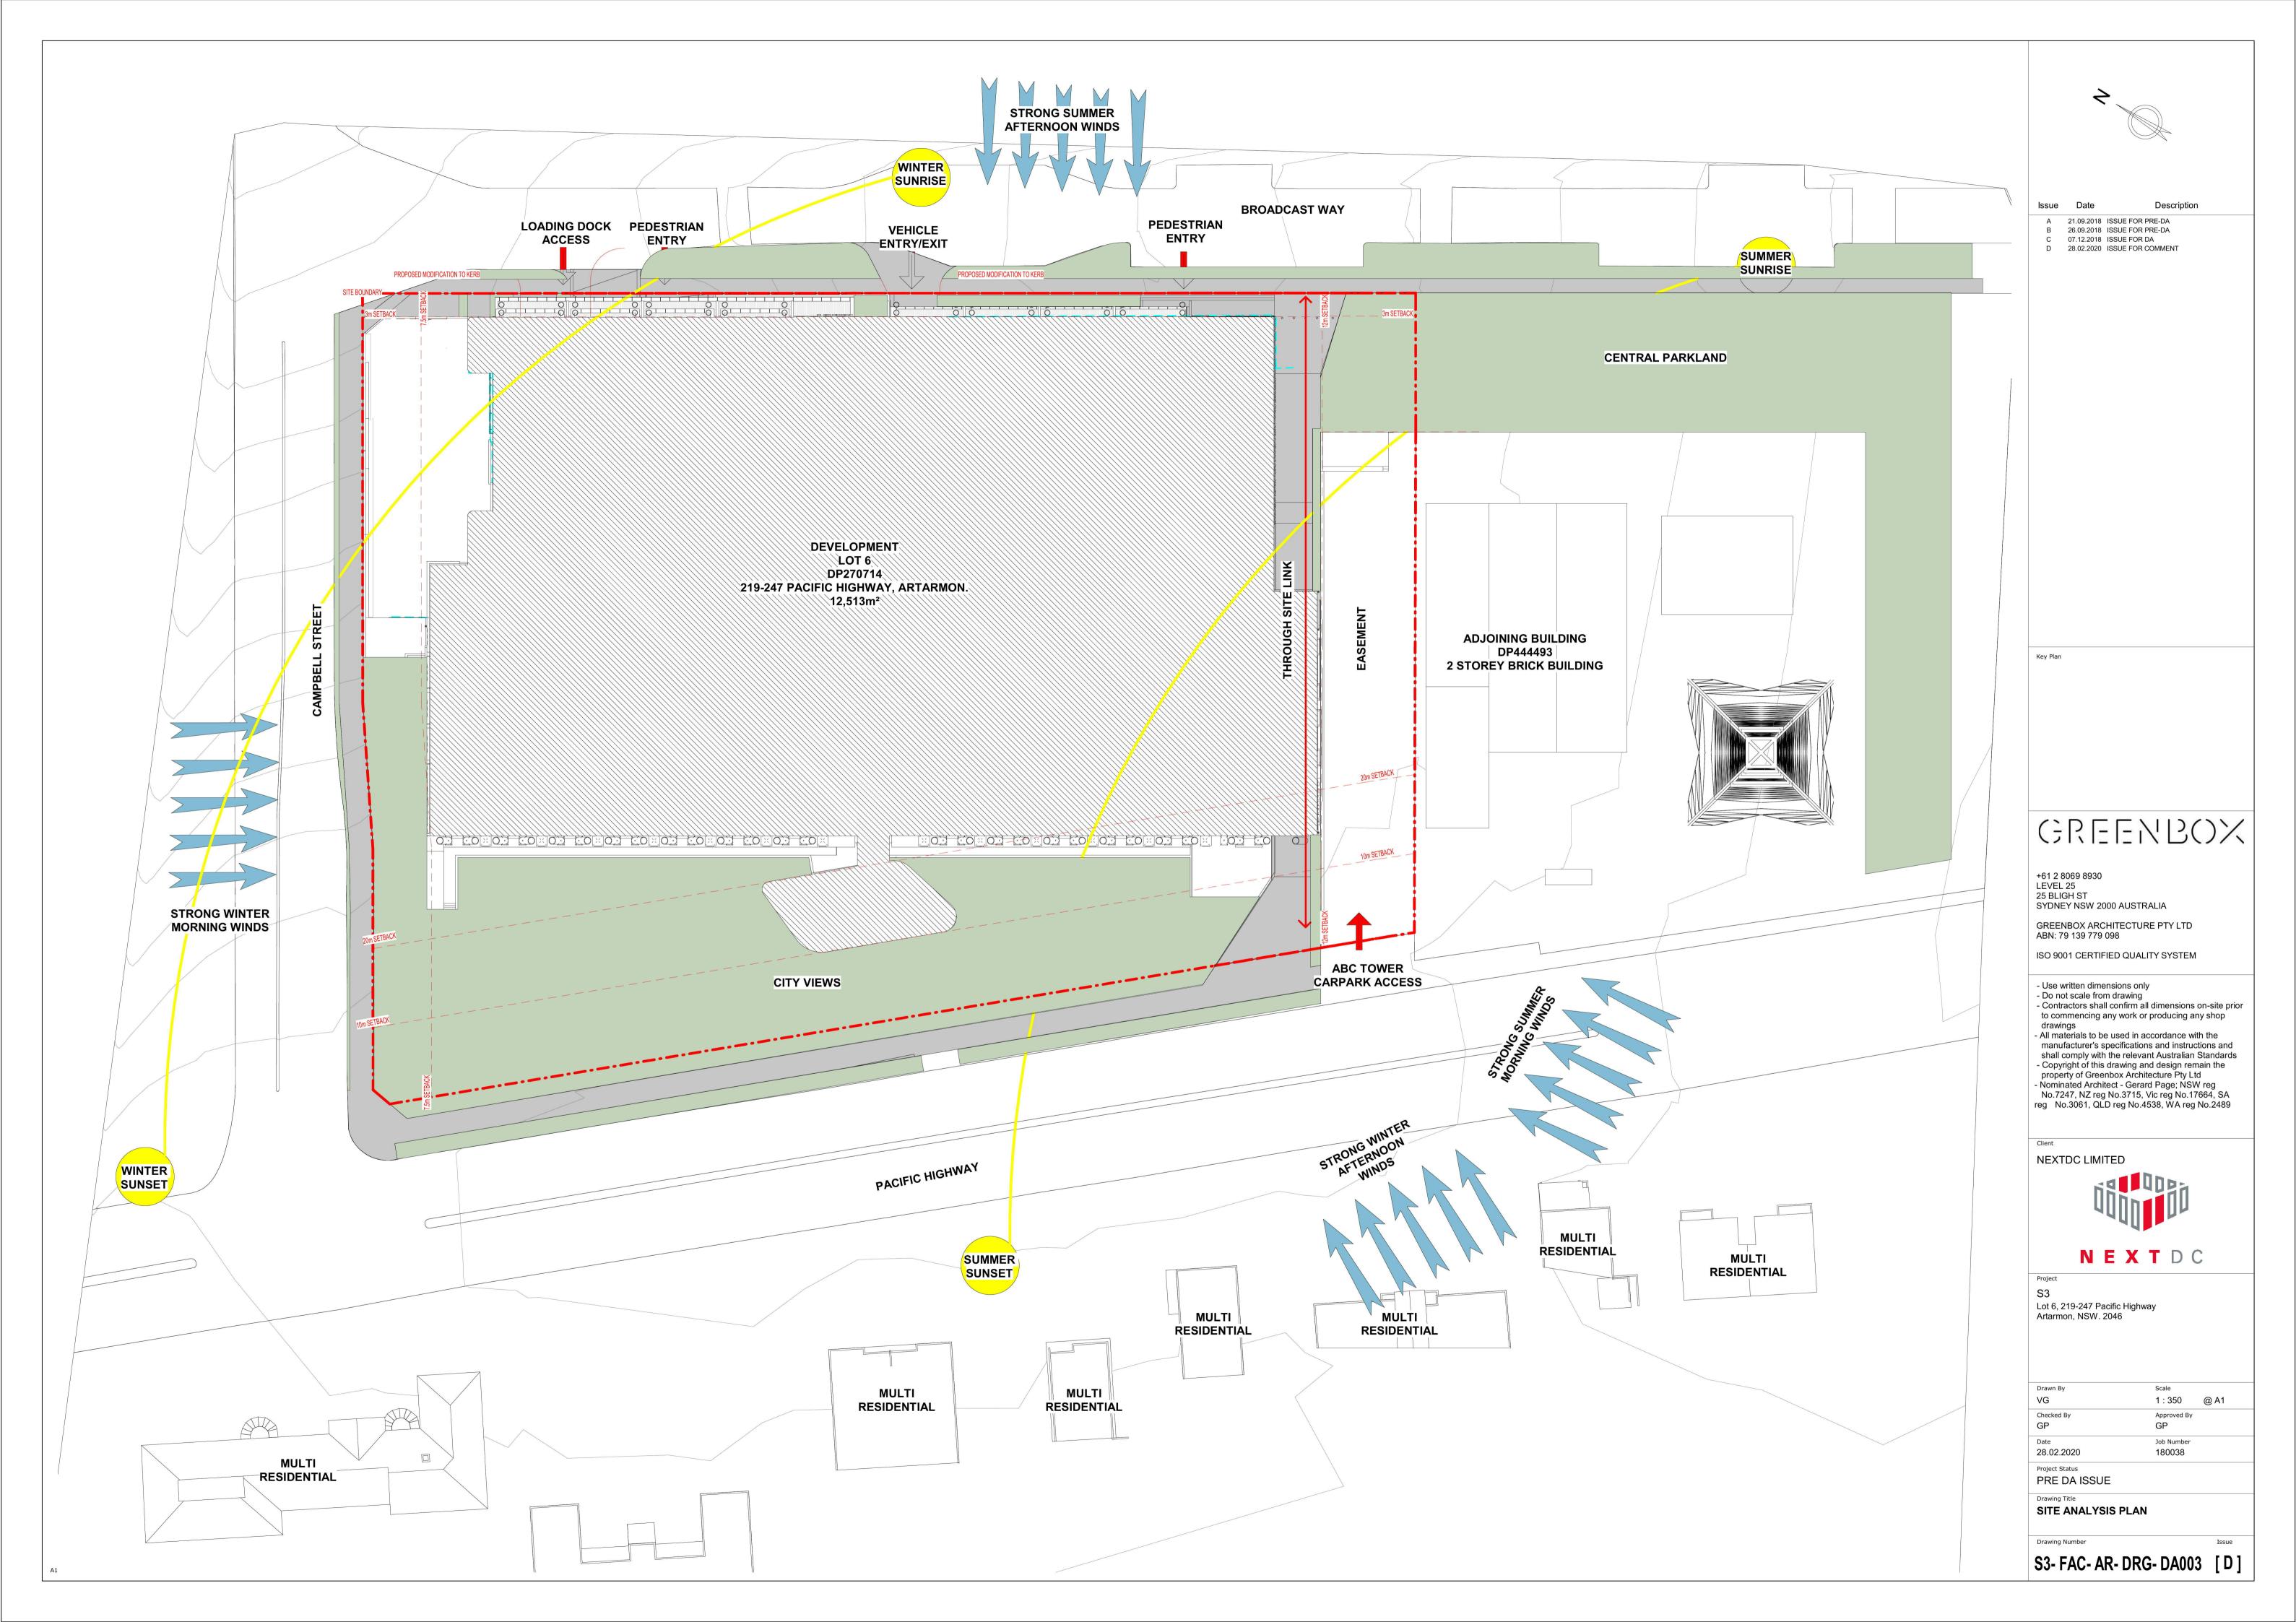
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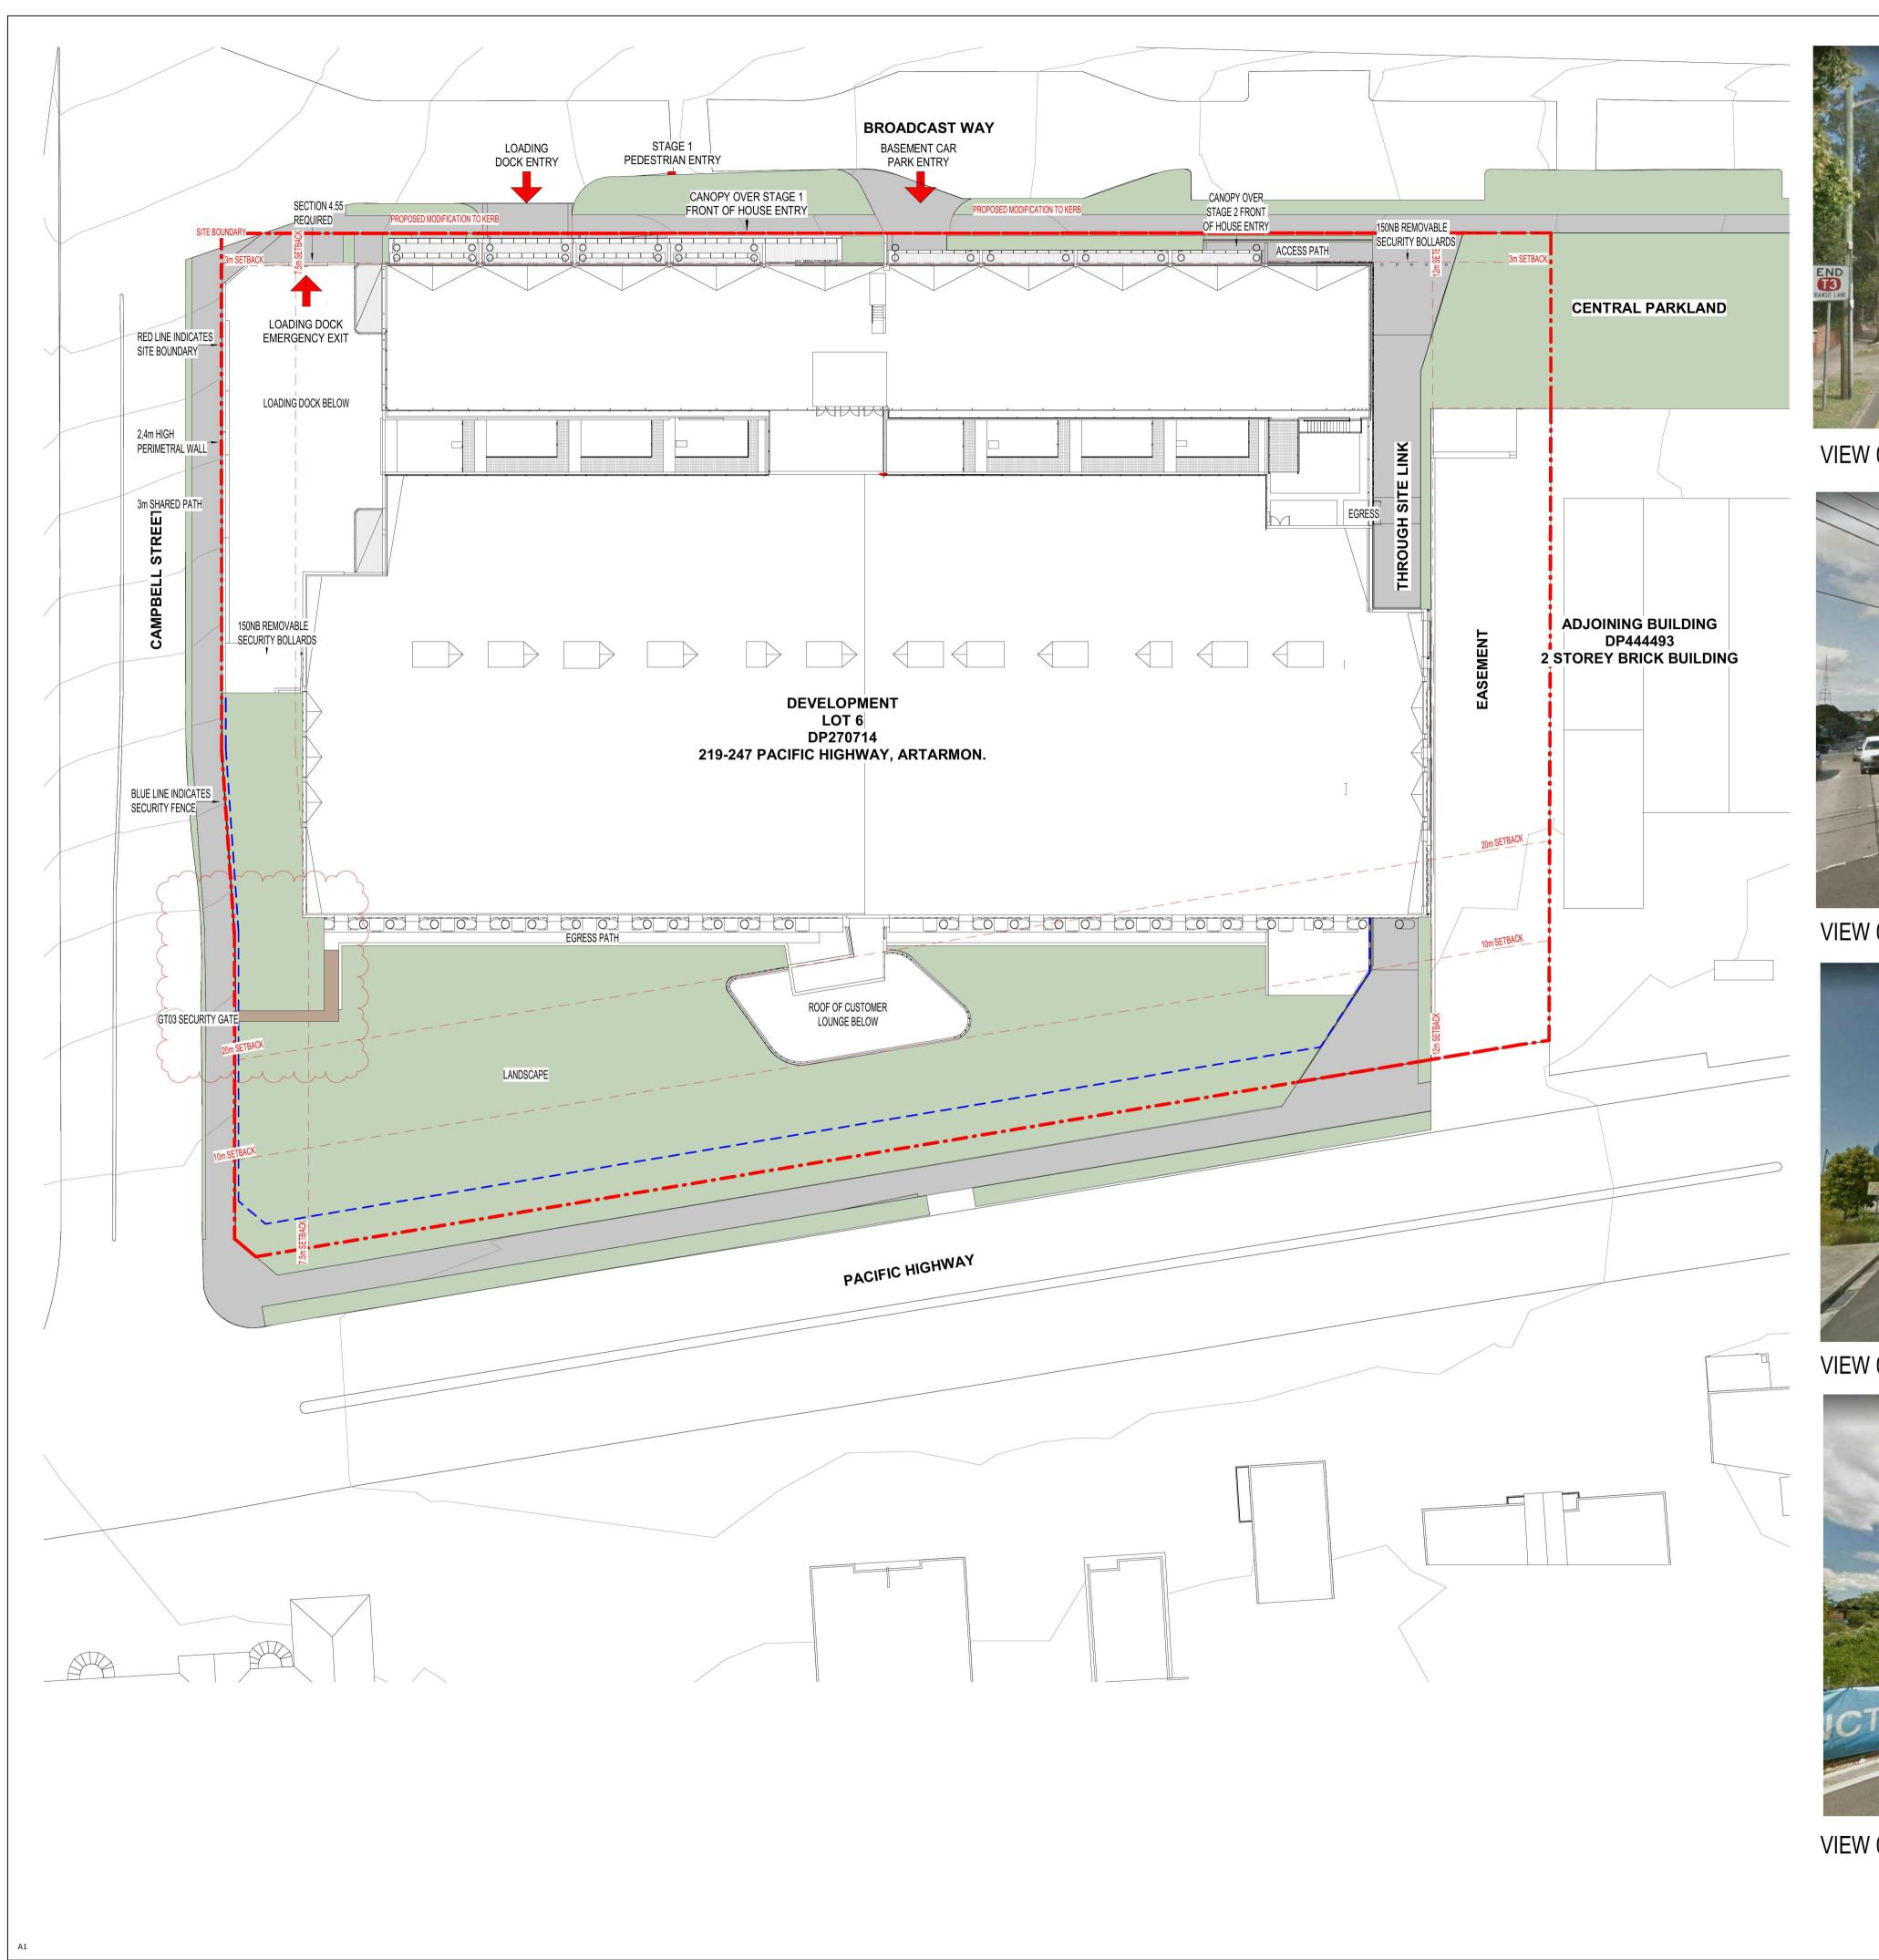
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**COVER SHEET** 

S3- FAC- AR- DRG- DA000 [F]







VIEW 01 (SOURCE - GOOGLE MAPS)




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VIEW 03 (SOURCE - GOOGLE MAPS)



VIEW 04 (SOURCE - GOOGLE MAPS)



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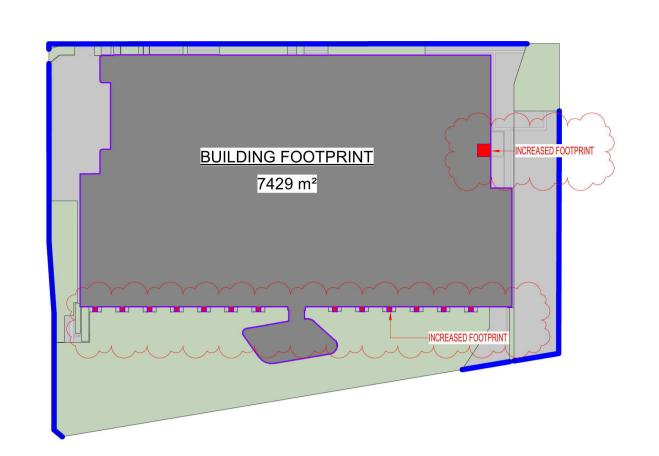

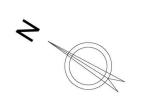
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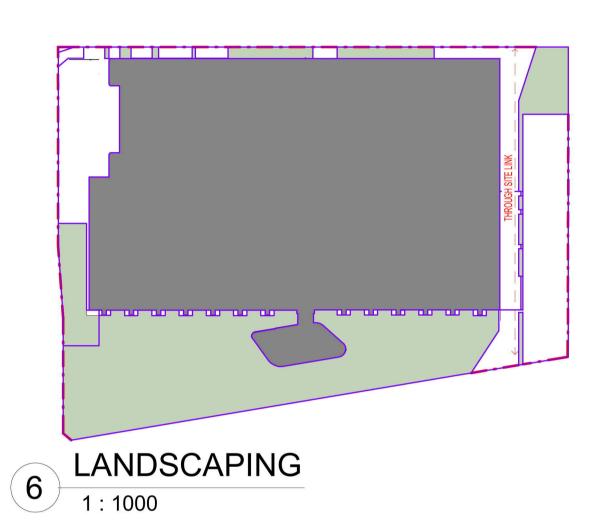
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Drawing Title SITE PLAN

S3- FAC- AR- DRG- DA005 [E]




# **BUILDING FOOTPRINT**



	Area Sche	/ F			
	Name	Area	%	7 -	
2	BUILDING FOOTPRINT*	7429 m²	59.31%		
	LANDSCAPED AREA**	3157 m <sup>2</sup>	25.20%		
	OTHER	1940 m²	15.49%		
	TOTAL SITE	12513 m <sup>2</sup>	100%		

\*MAXIMUM ALLOWED FOOTPRINT - 60% OF TOTAL SITE AREA \*\*LANDSCAPED AREA REQUIRED - 25% OF TOTAL SITE AREA

LANDSCAPED AREA DEFINITION: a part of a site which is not occupied by any building and is available for use and enjoyment by the occupants of a building erected on the site. It includes areas used for swimming pools, open-air recreation areas, gardens, lawns, shrubs or trees, but does not include areas used for driveways, parking areas, drying yards, garbage storage areas or public open space.

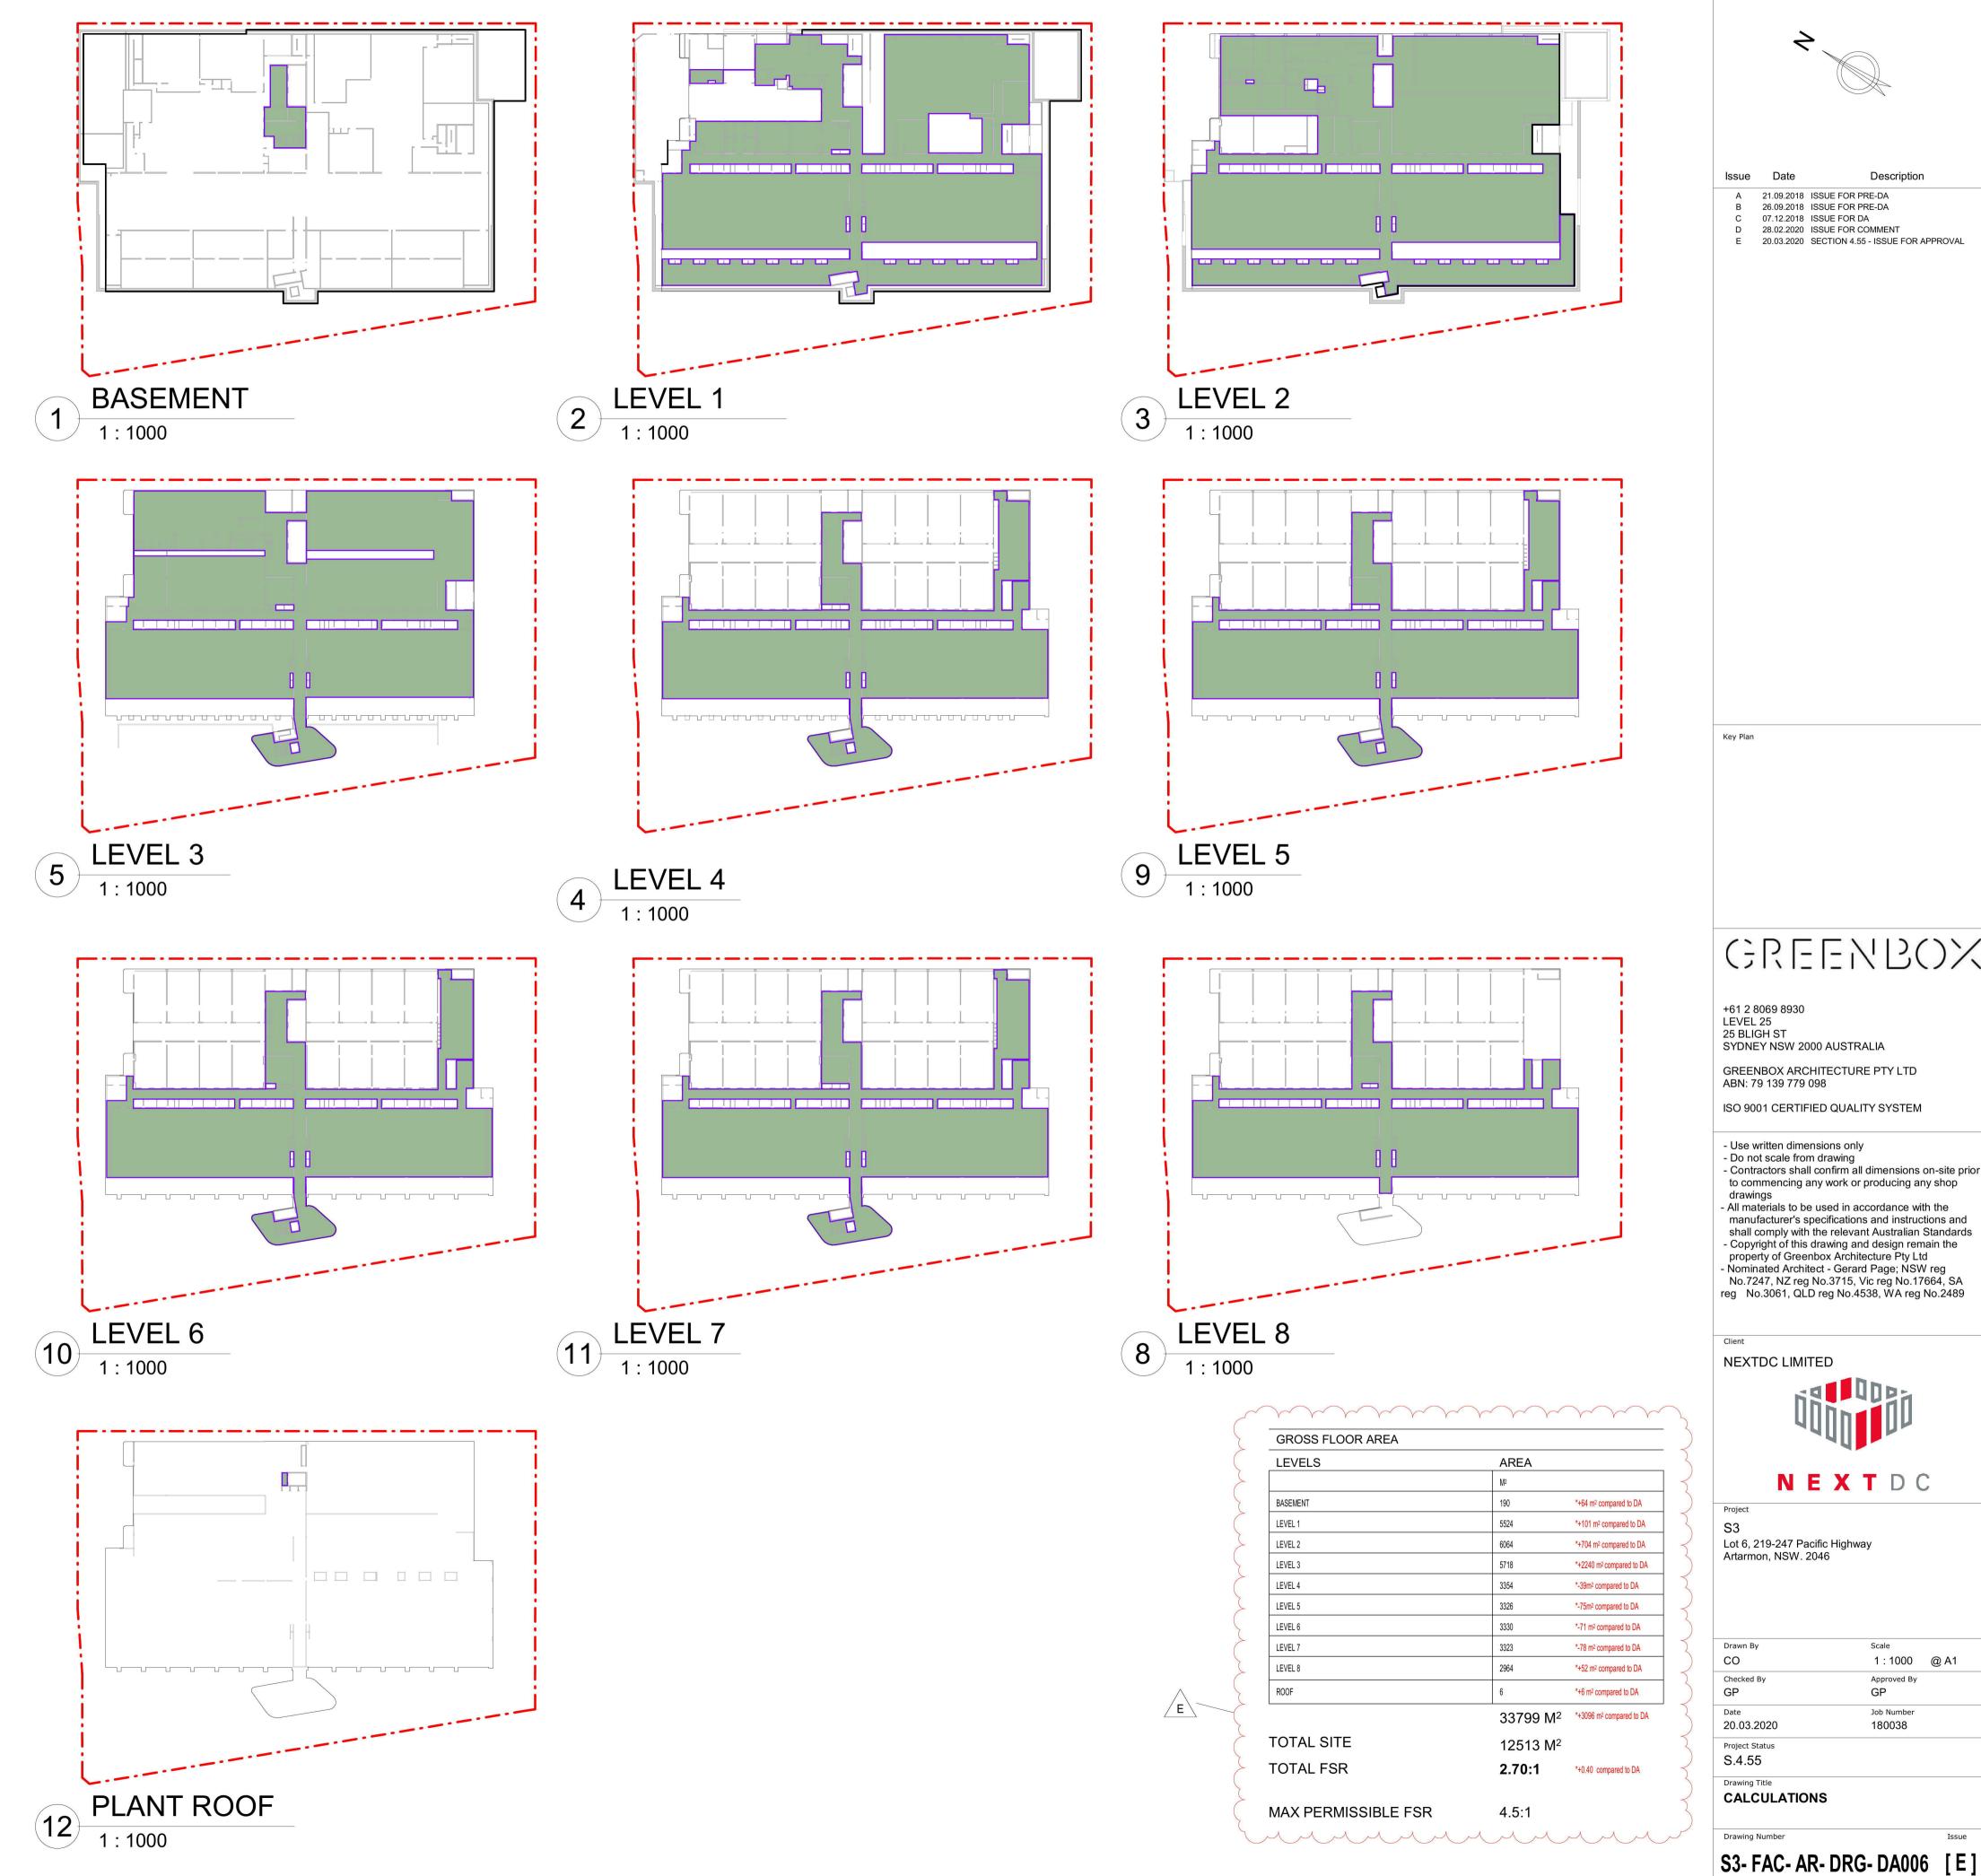



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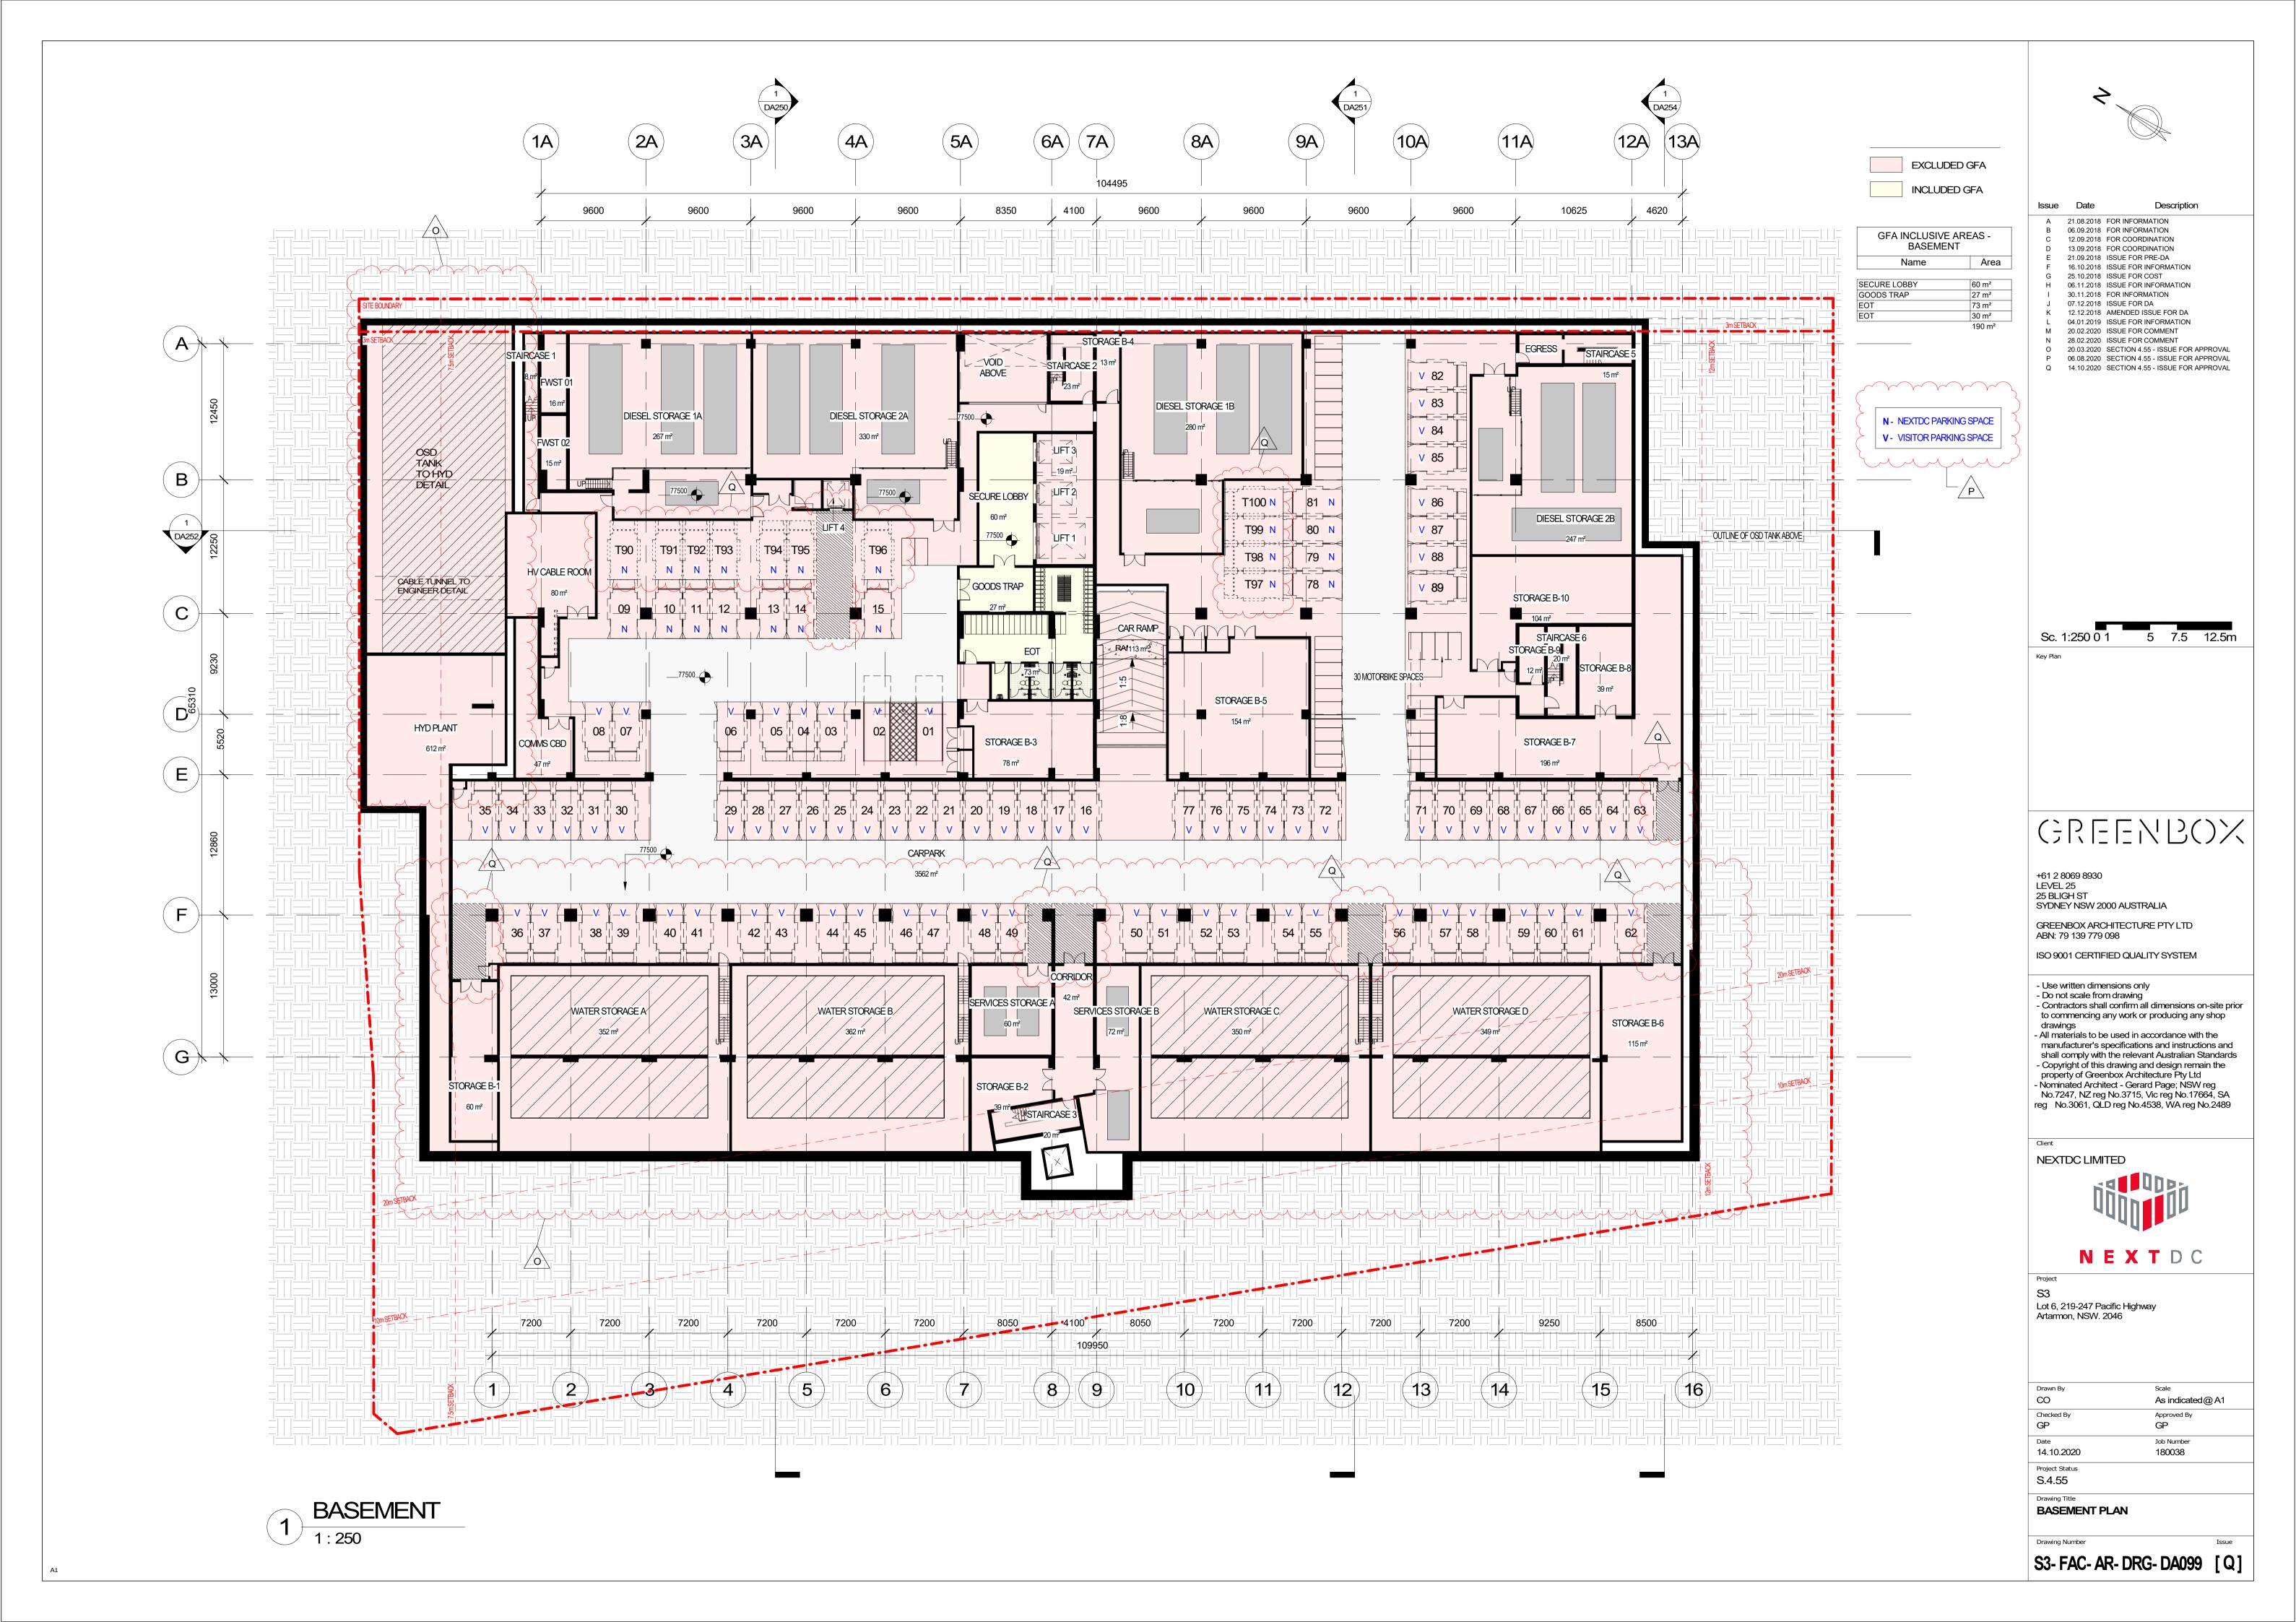
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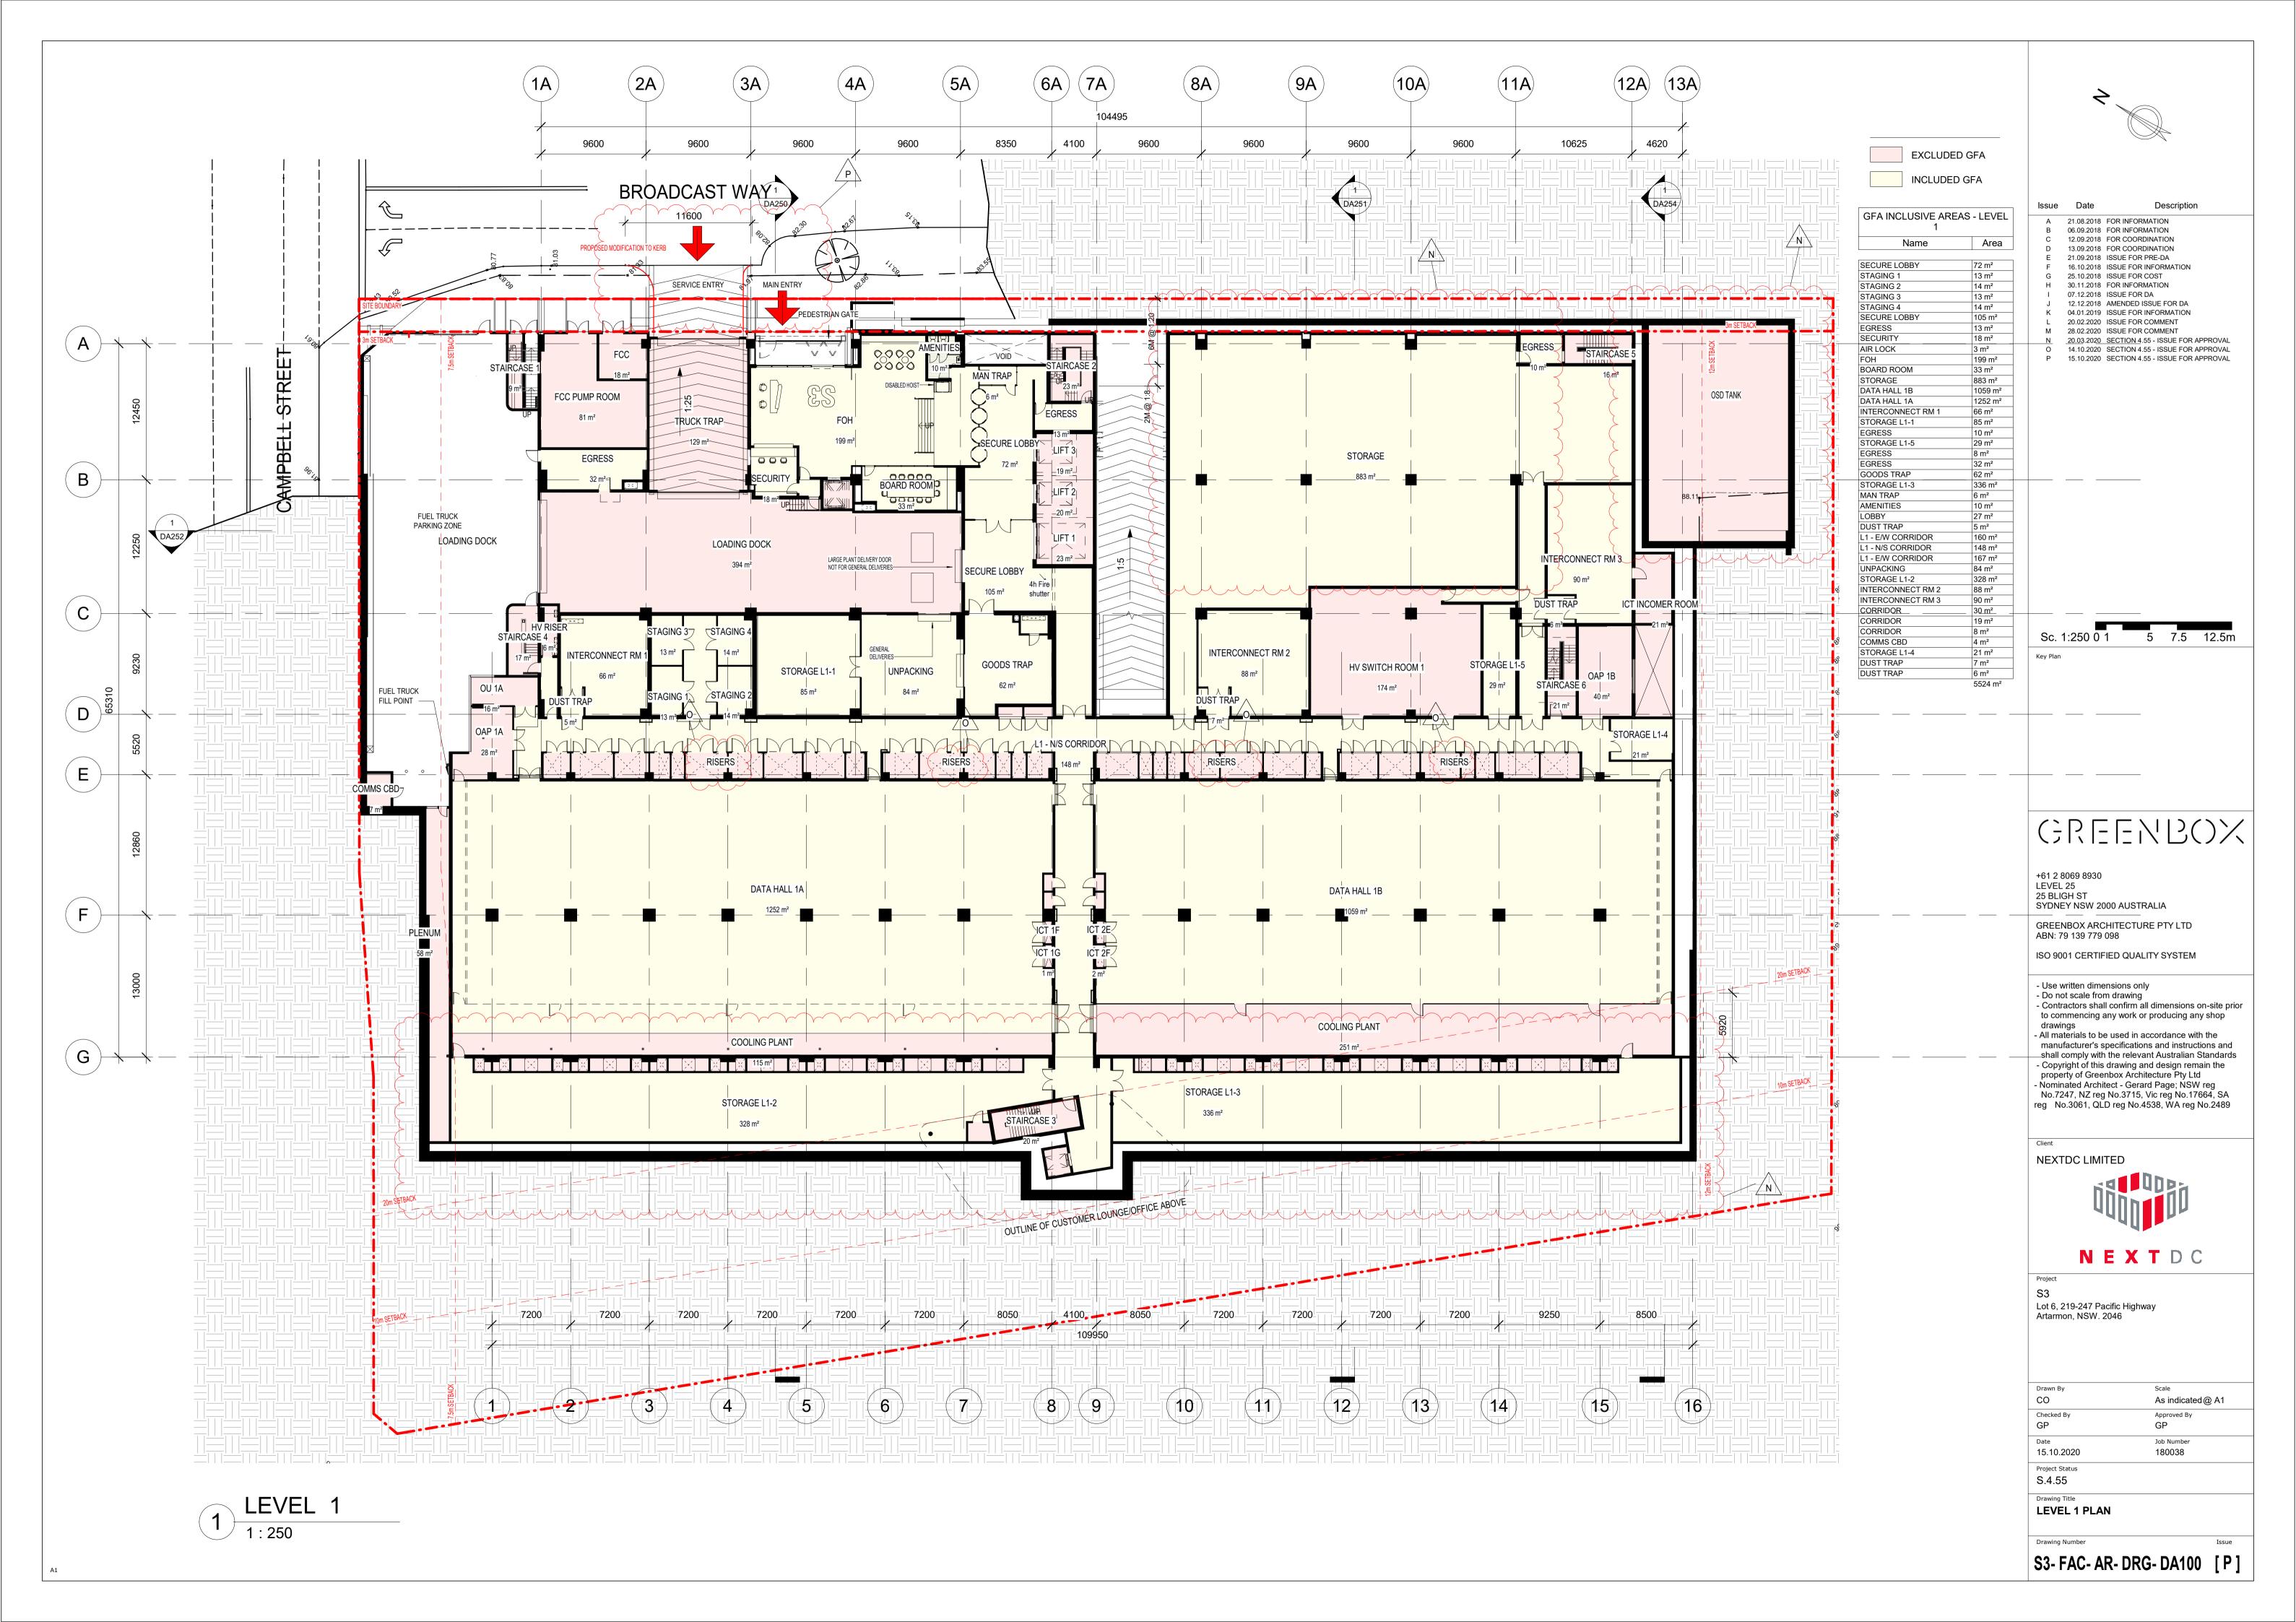



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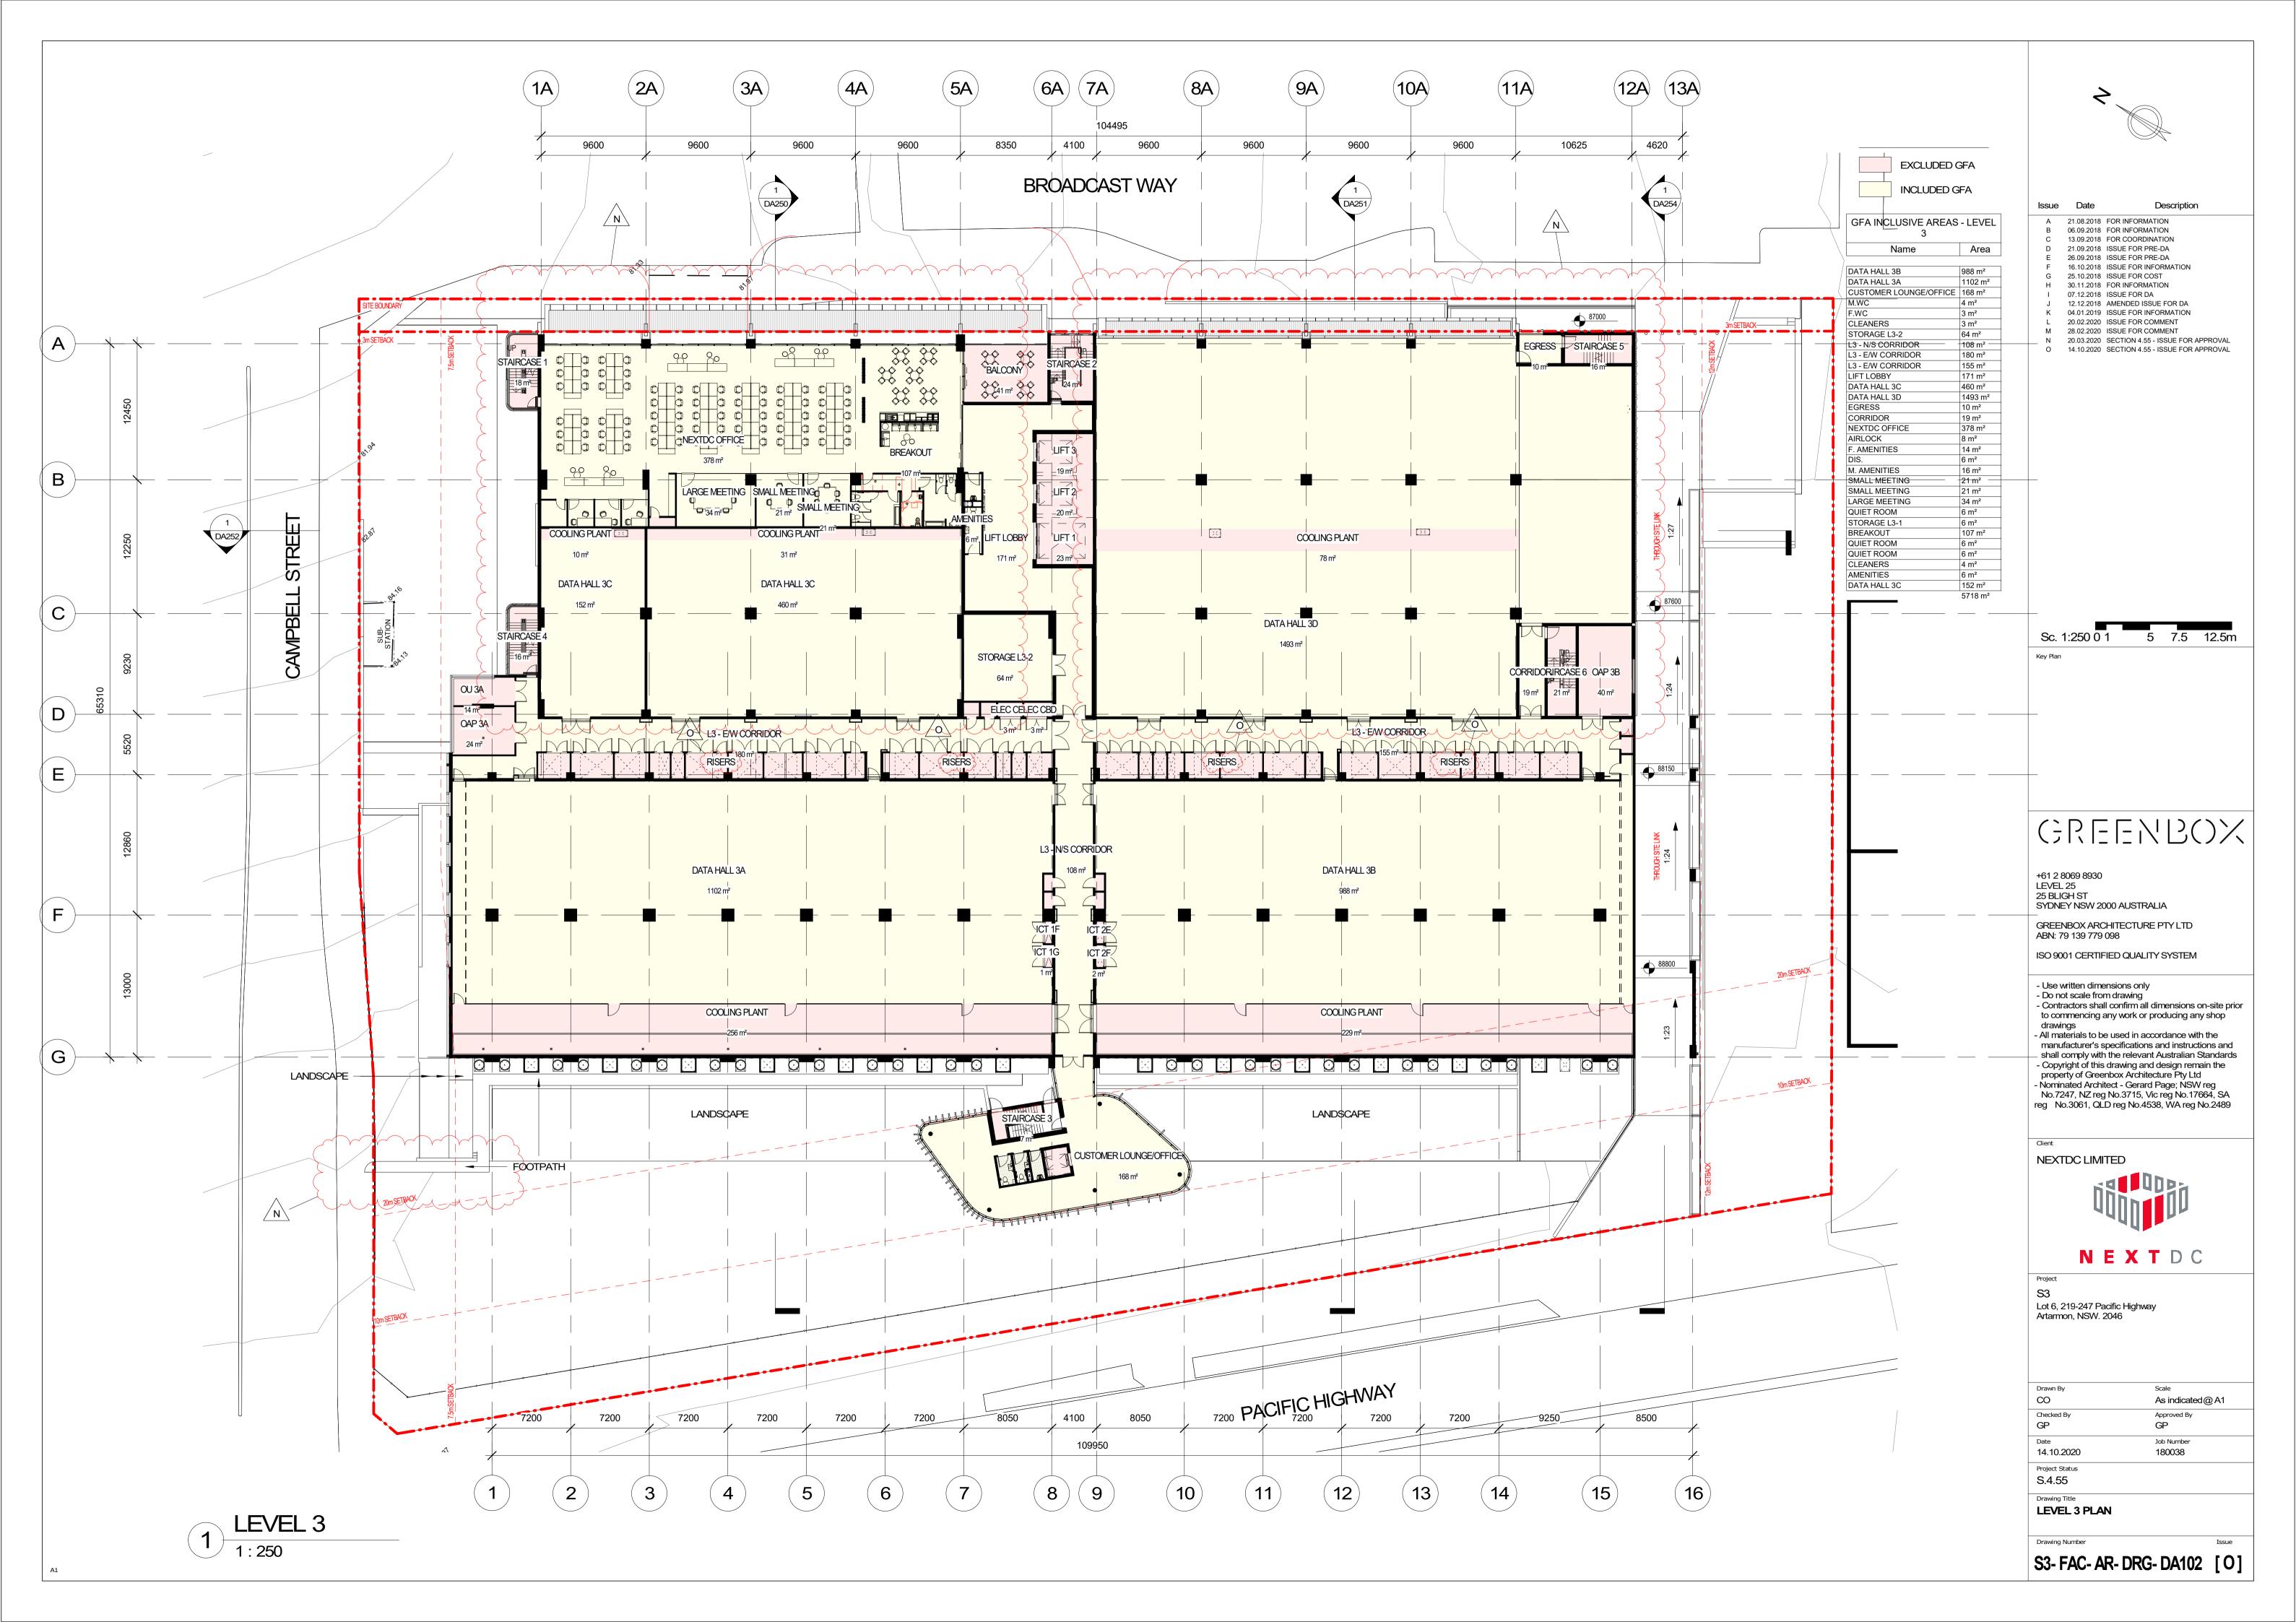
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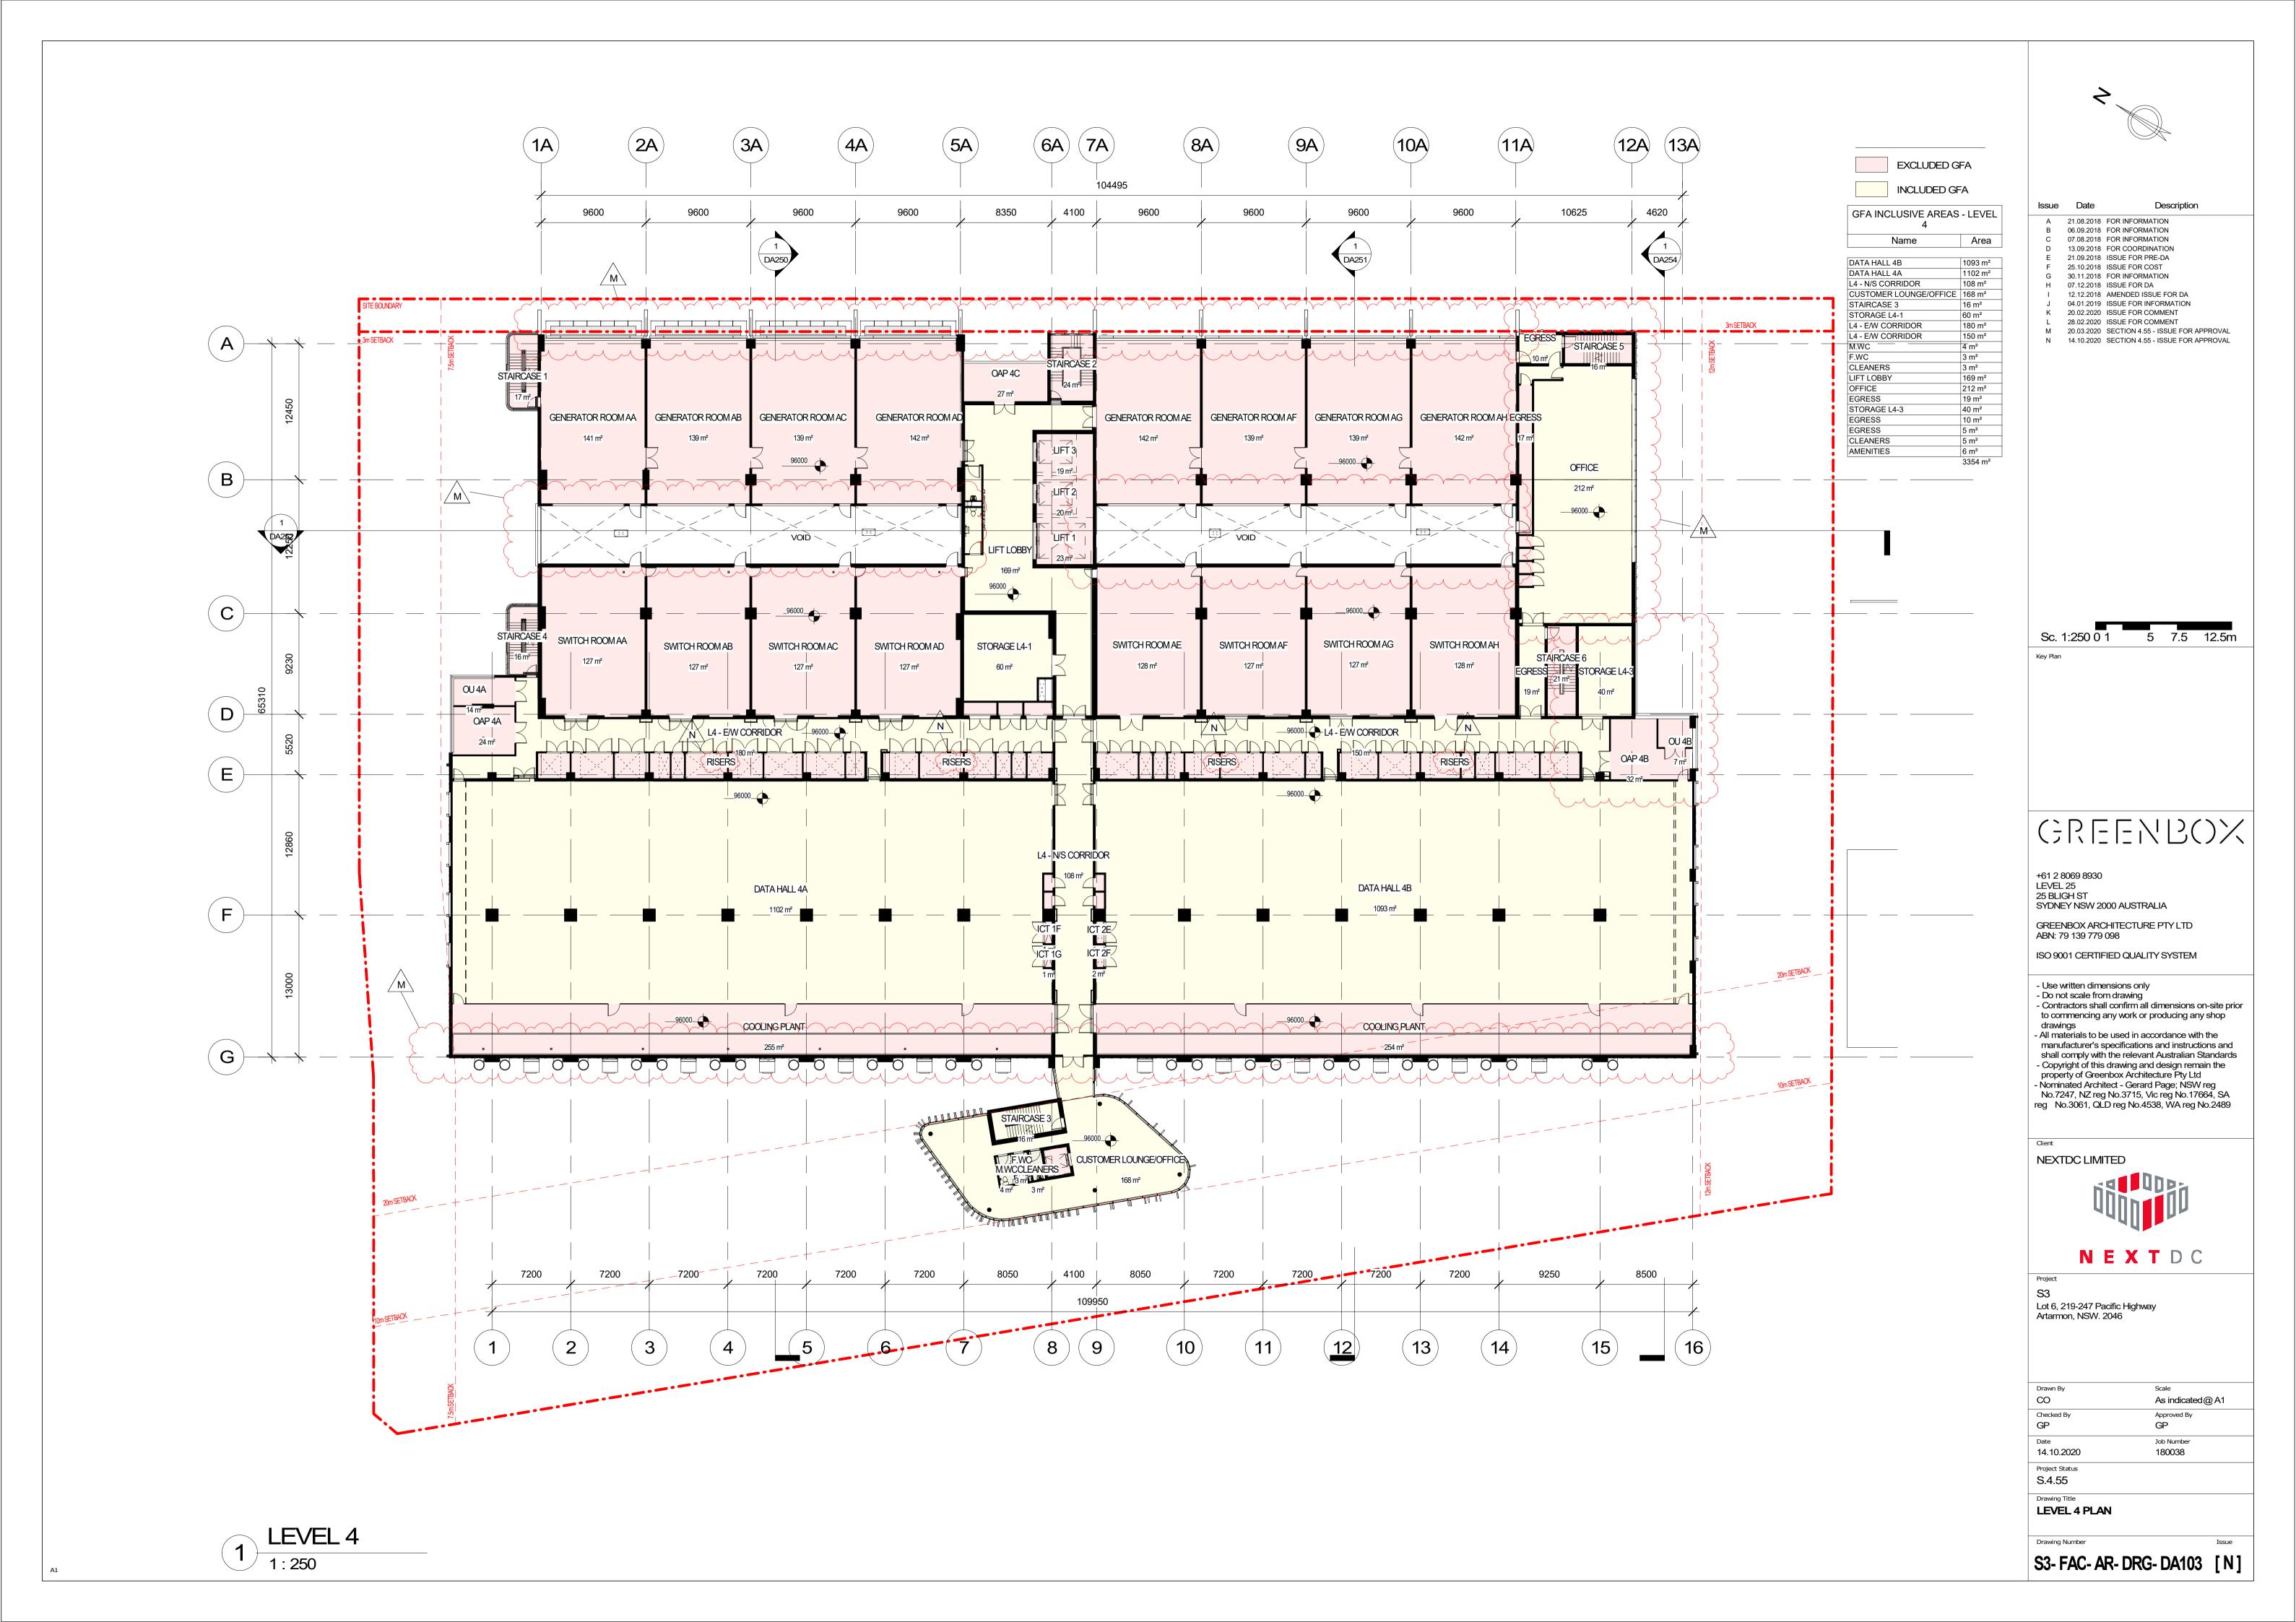
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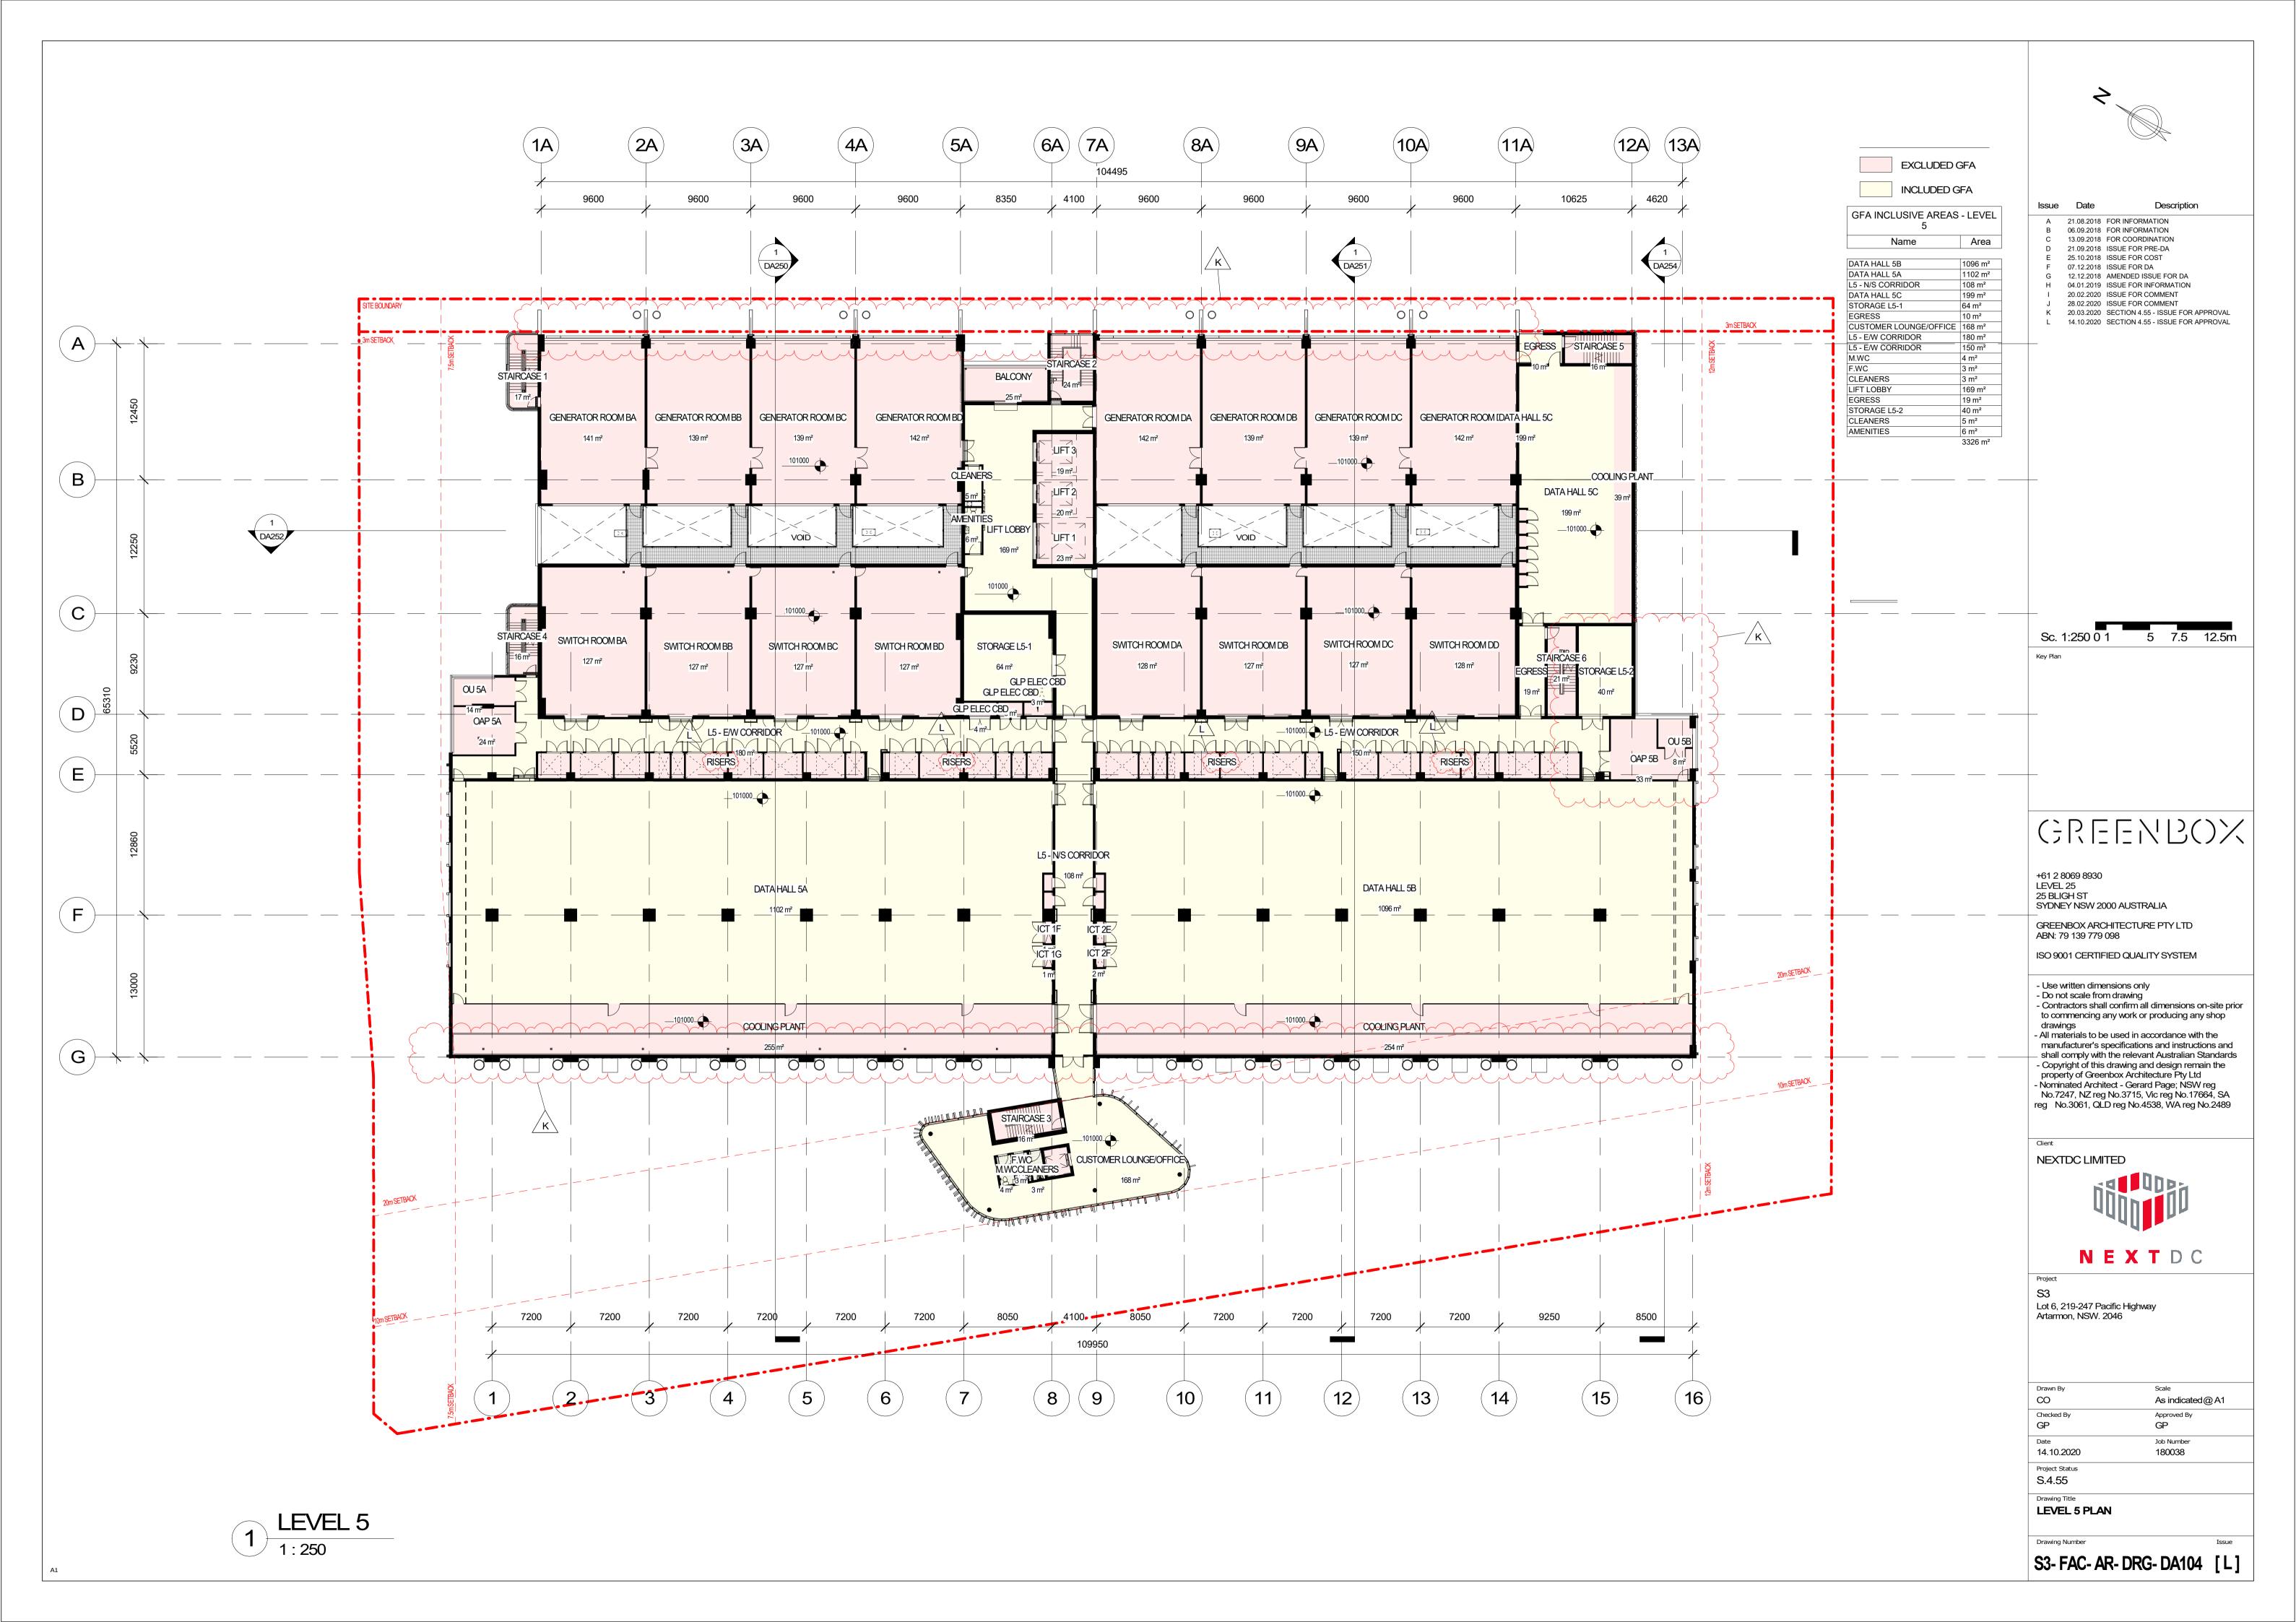














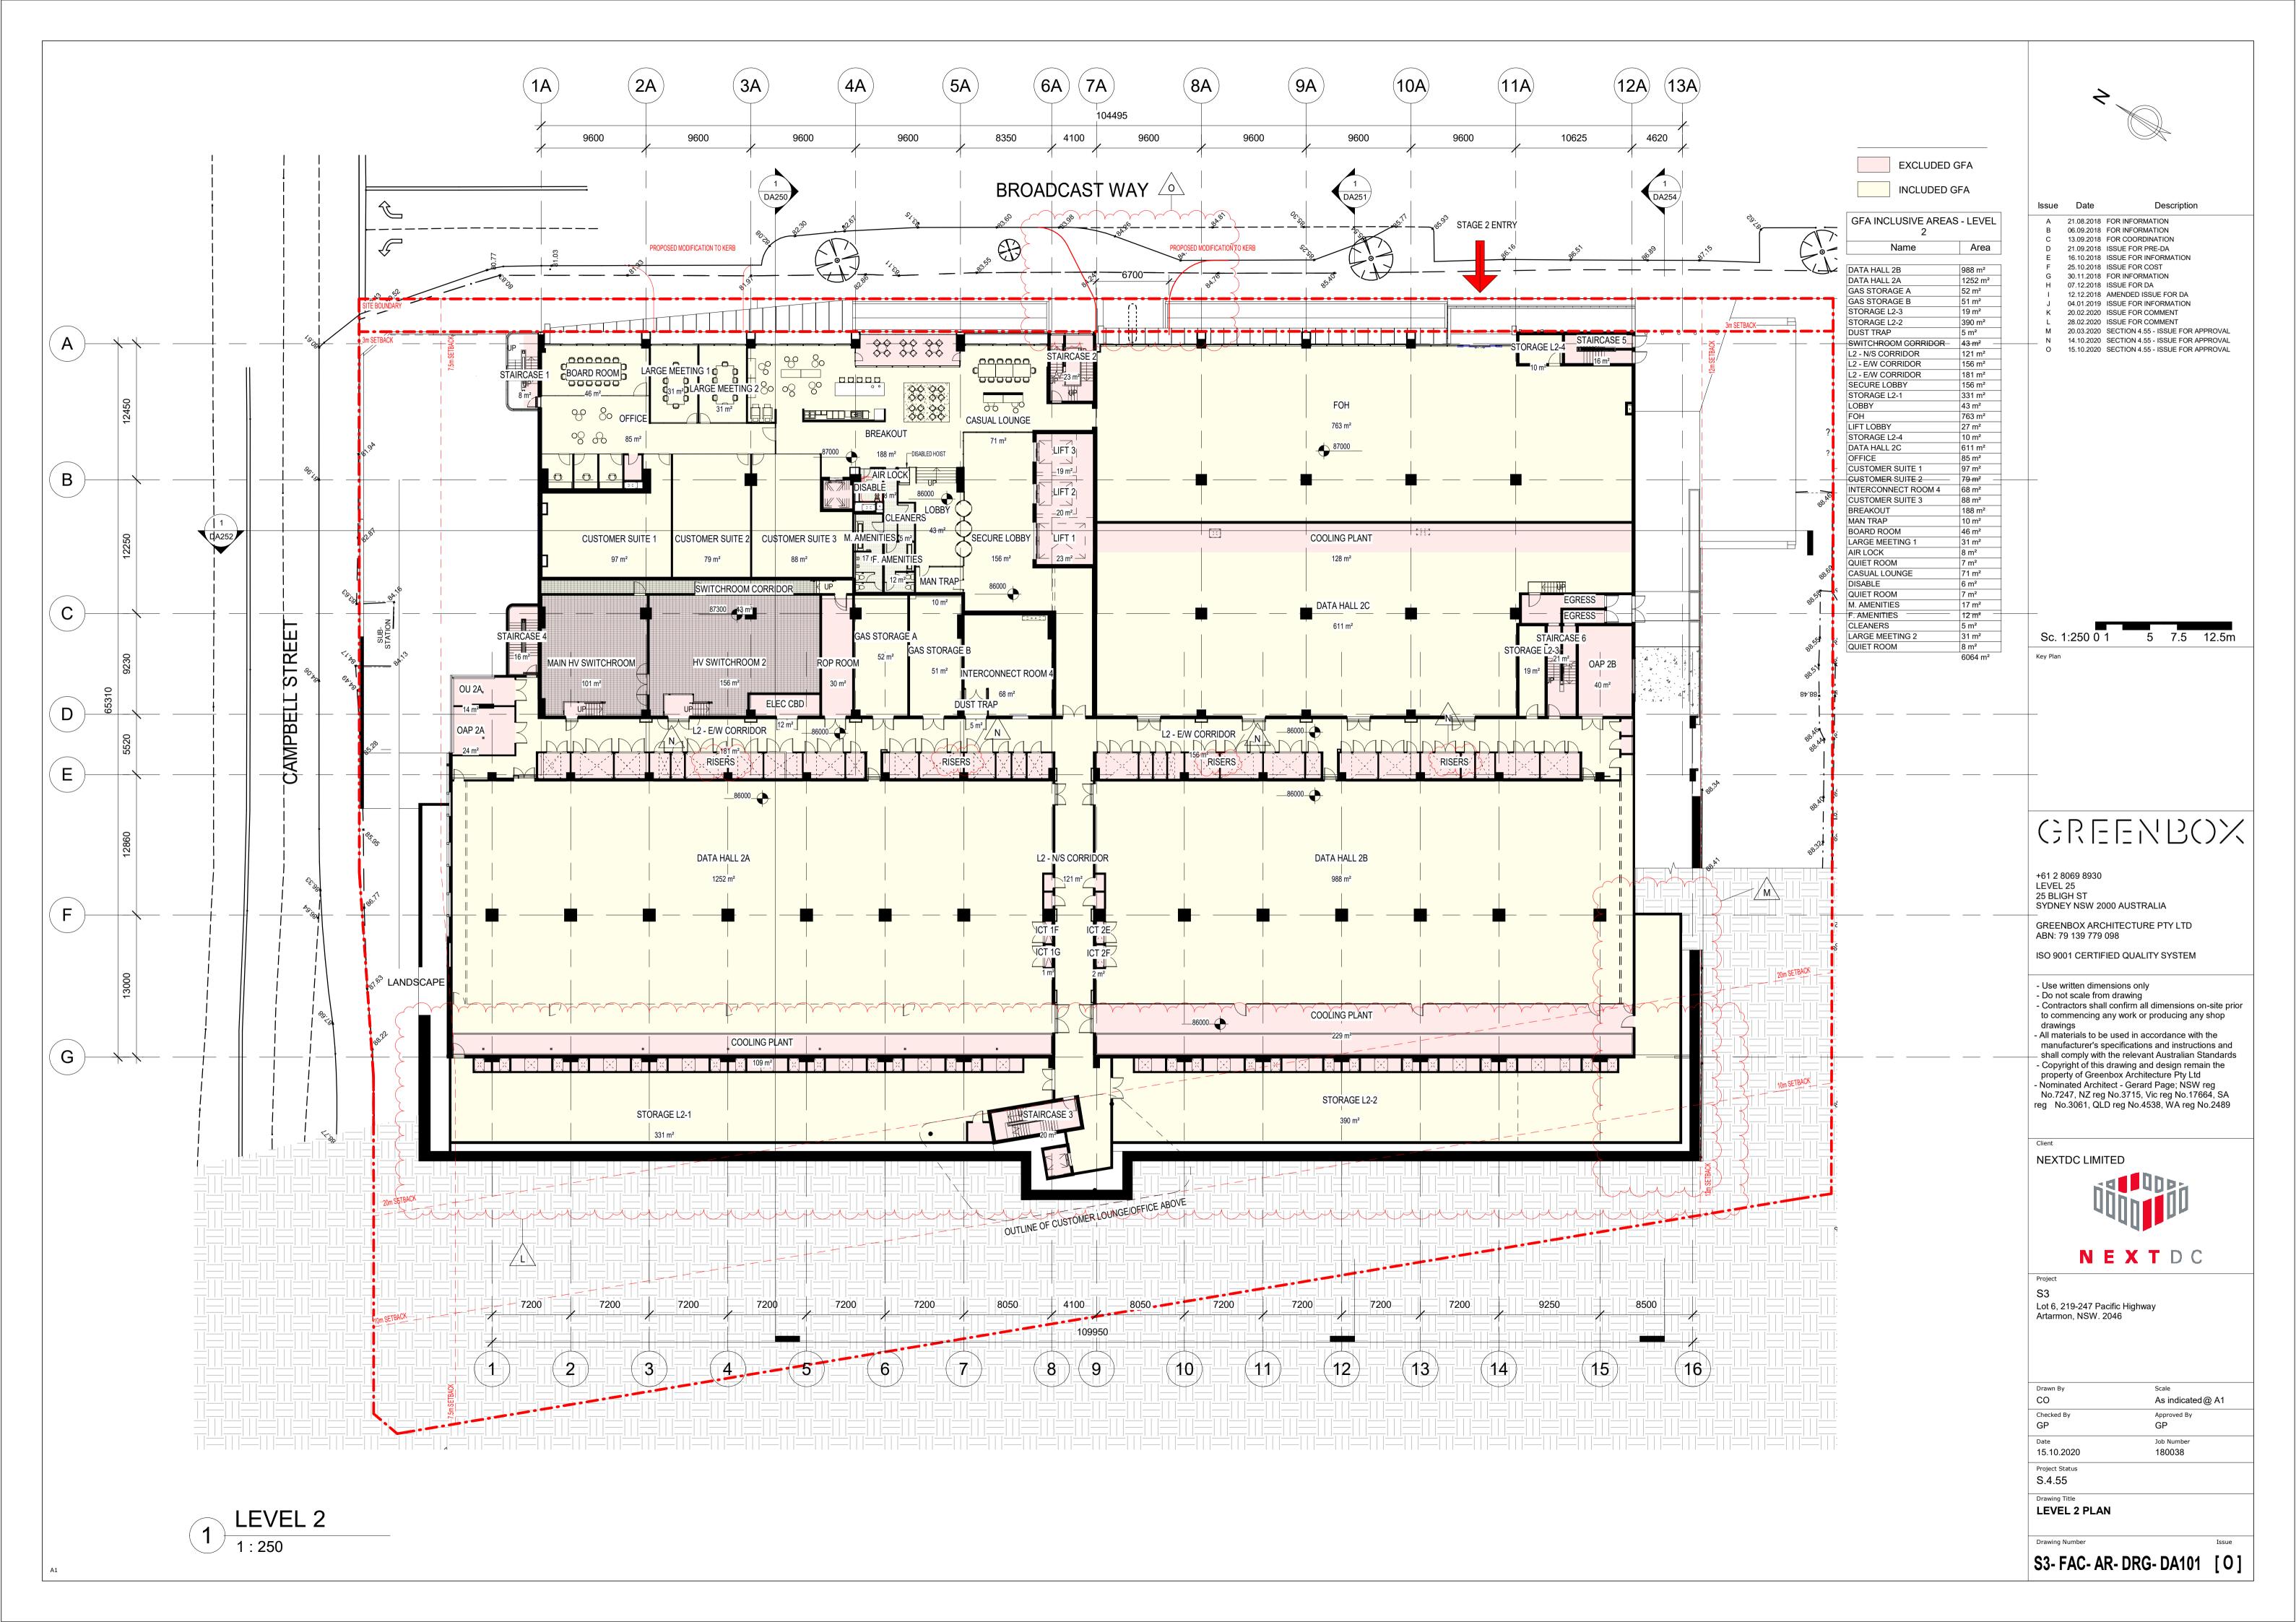


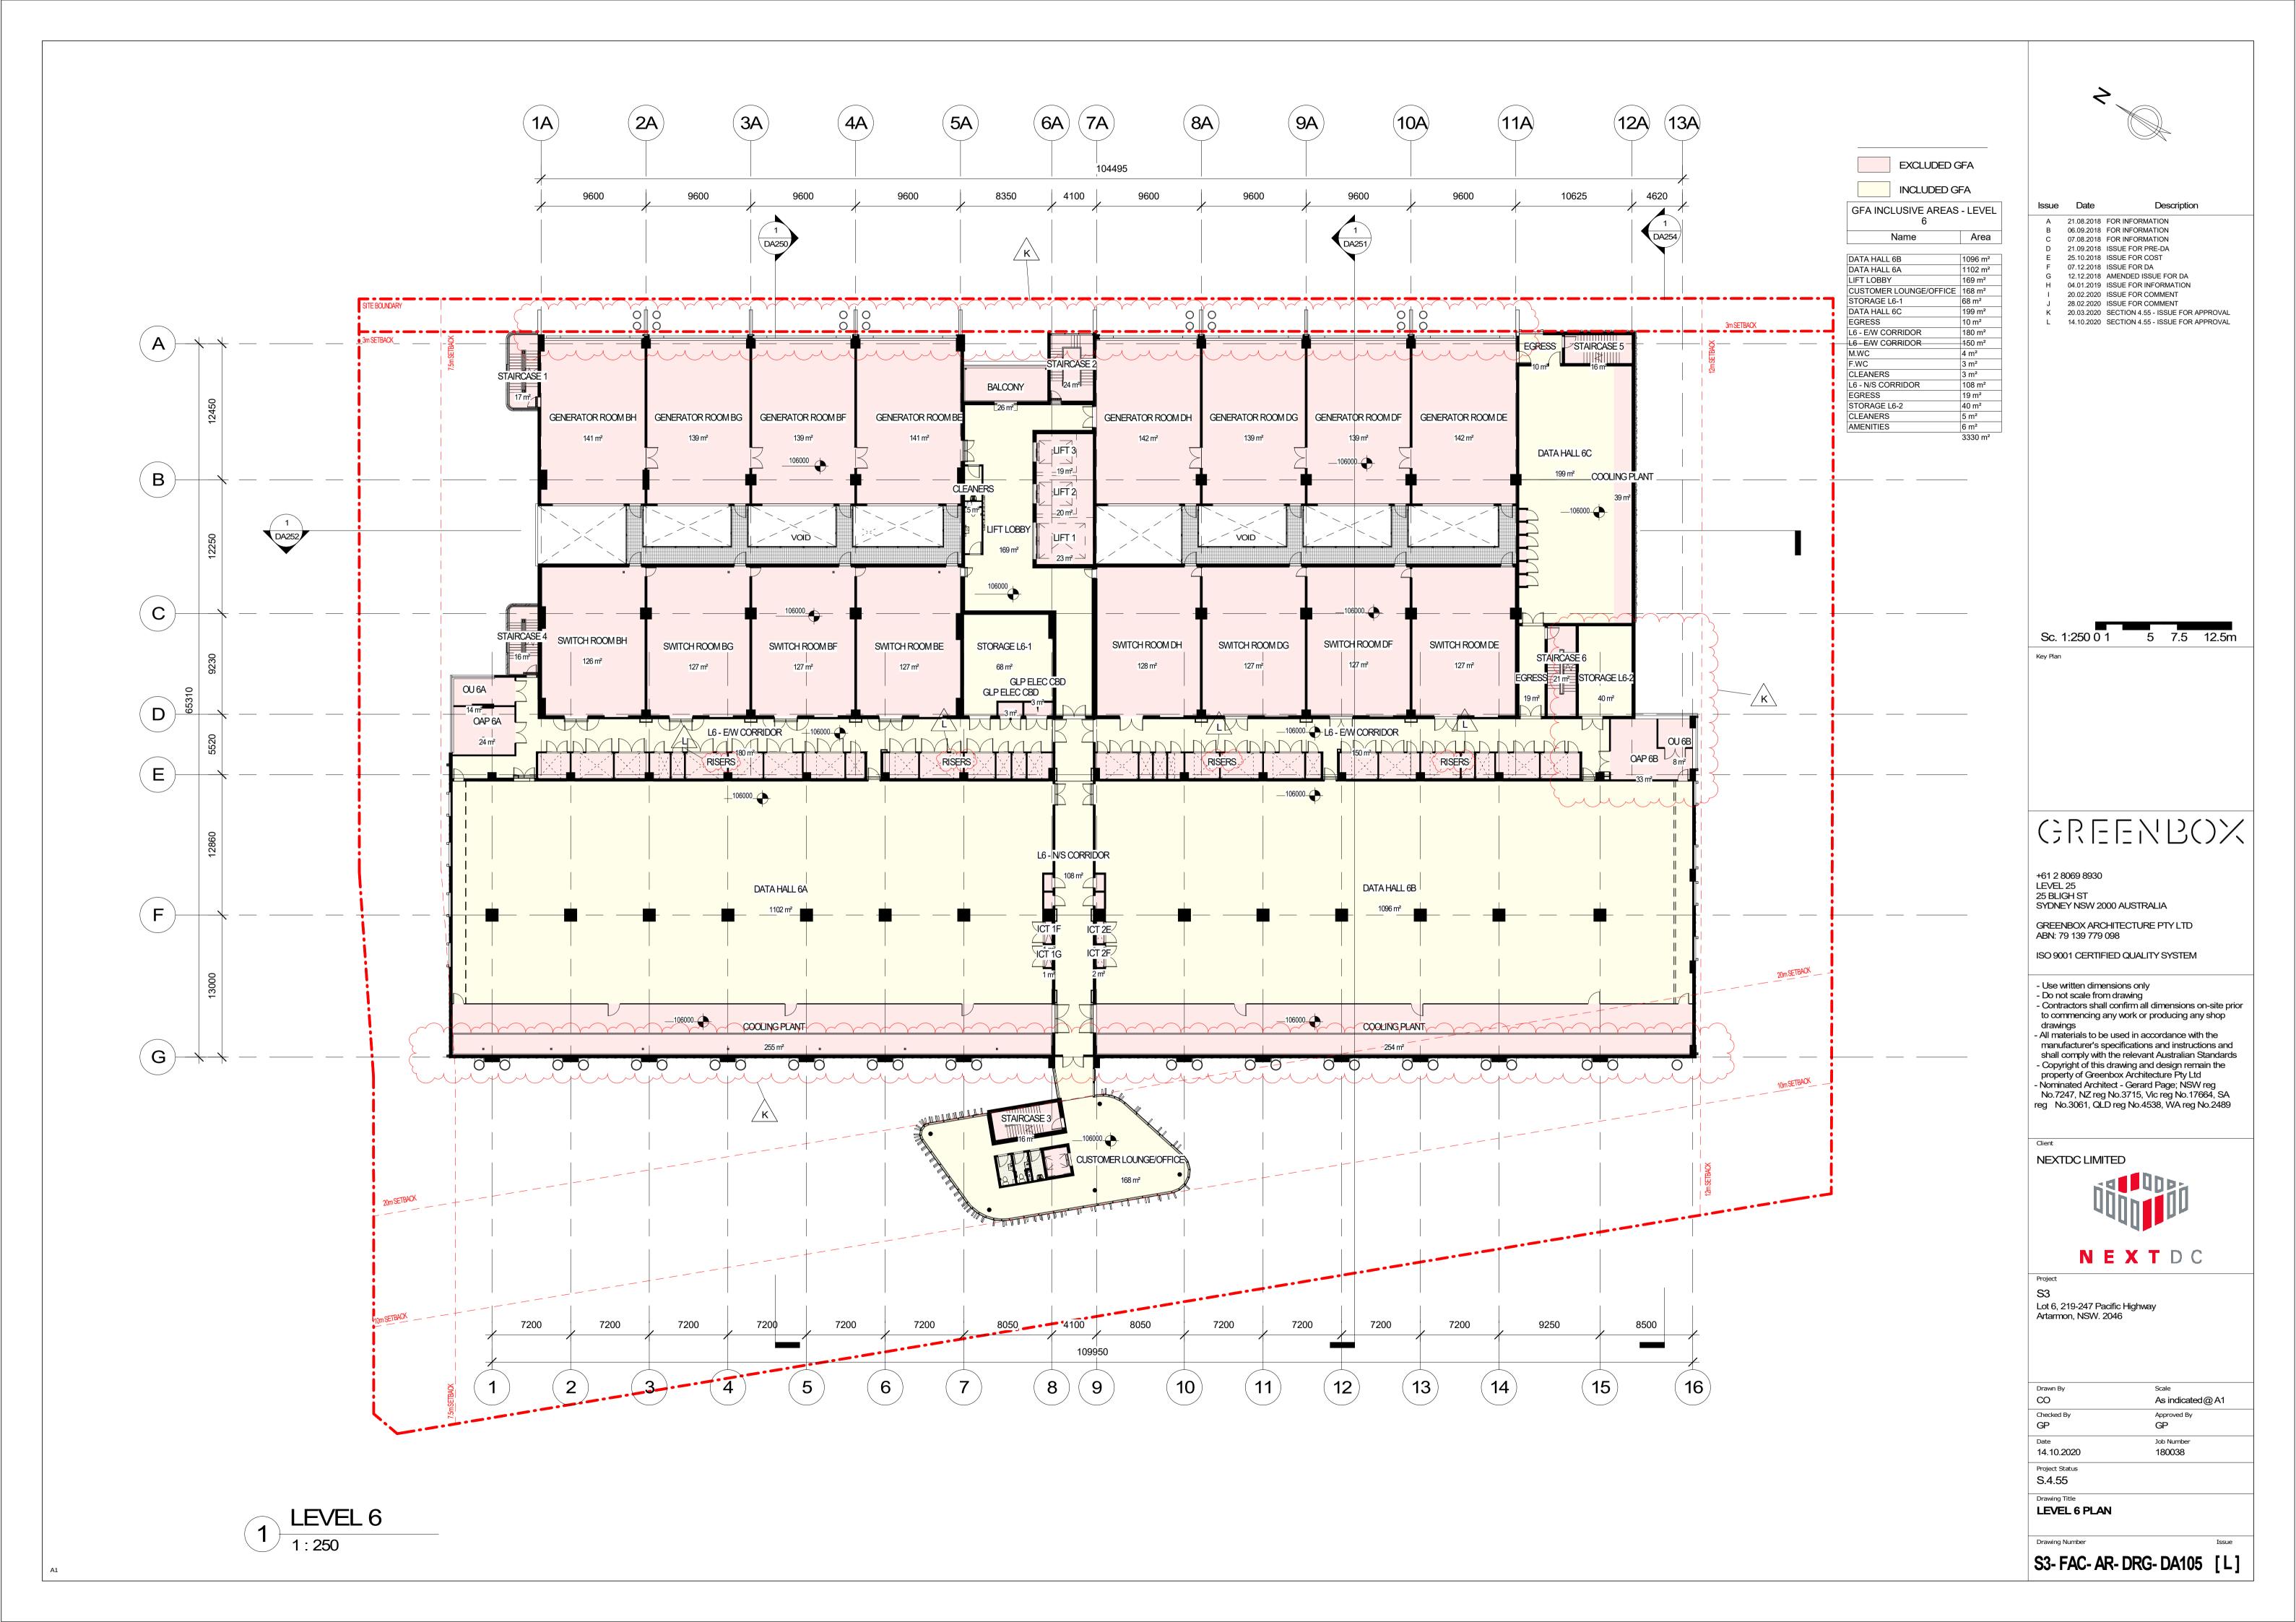


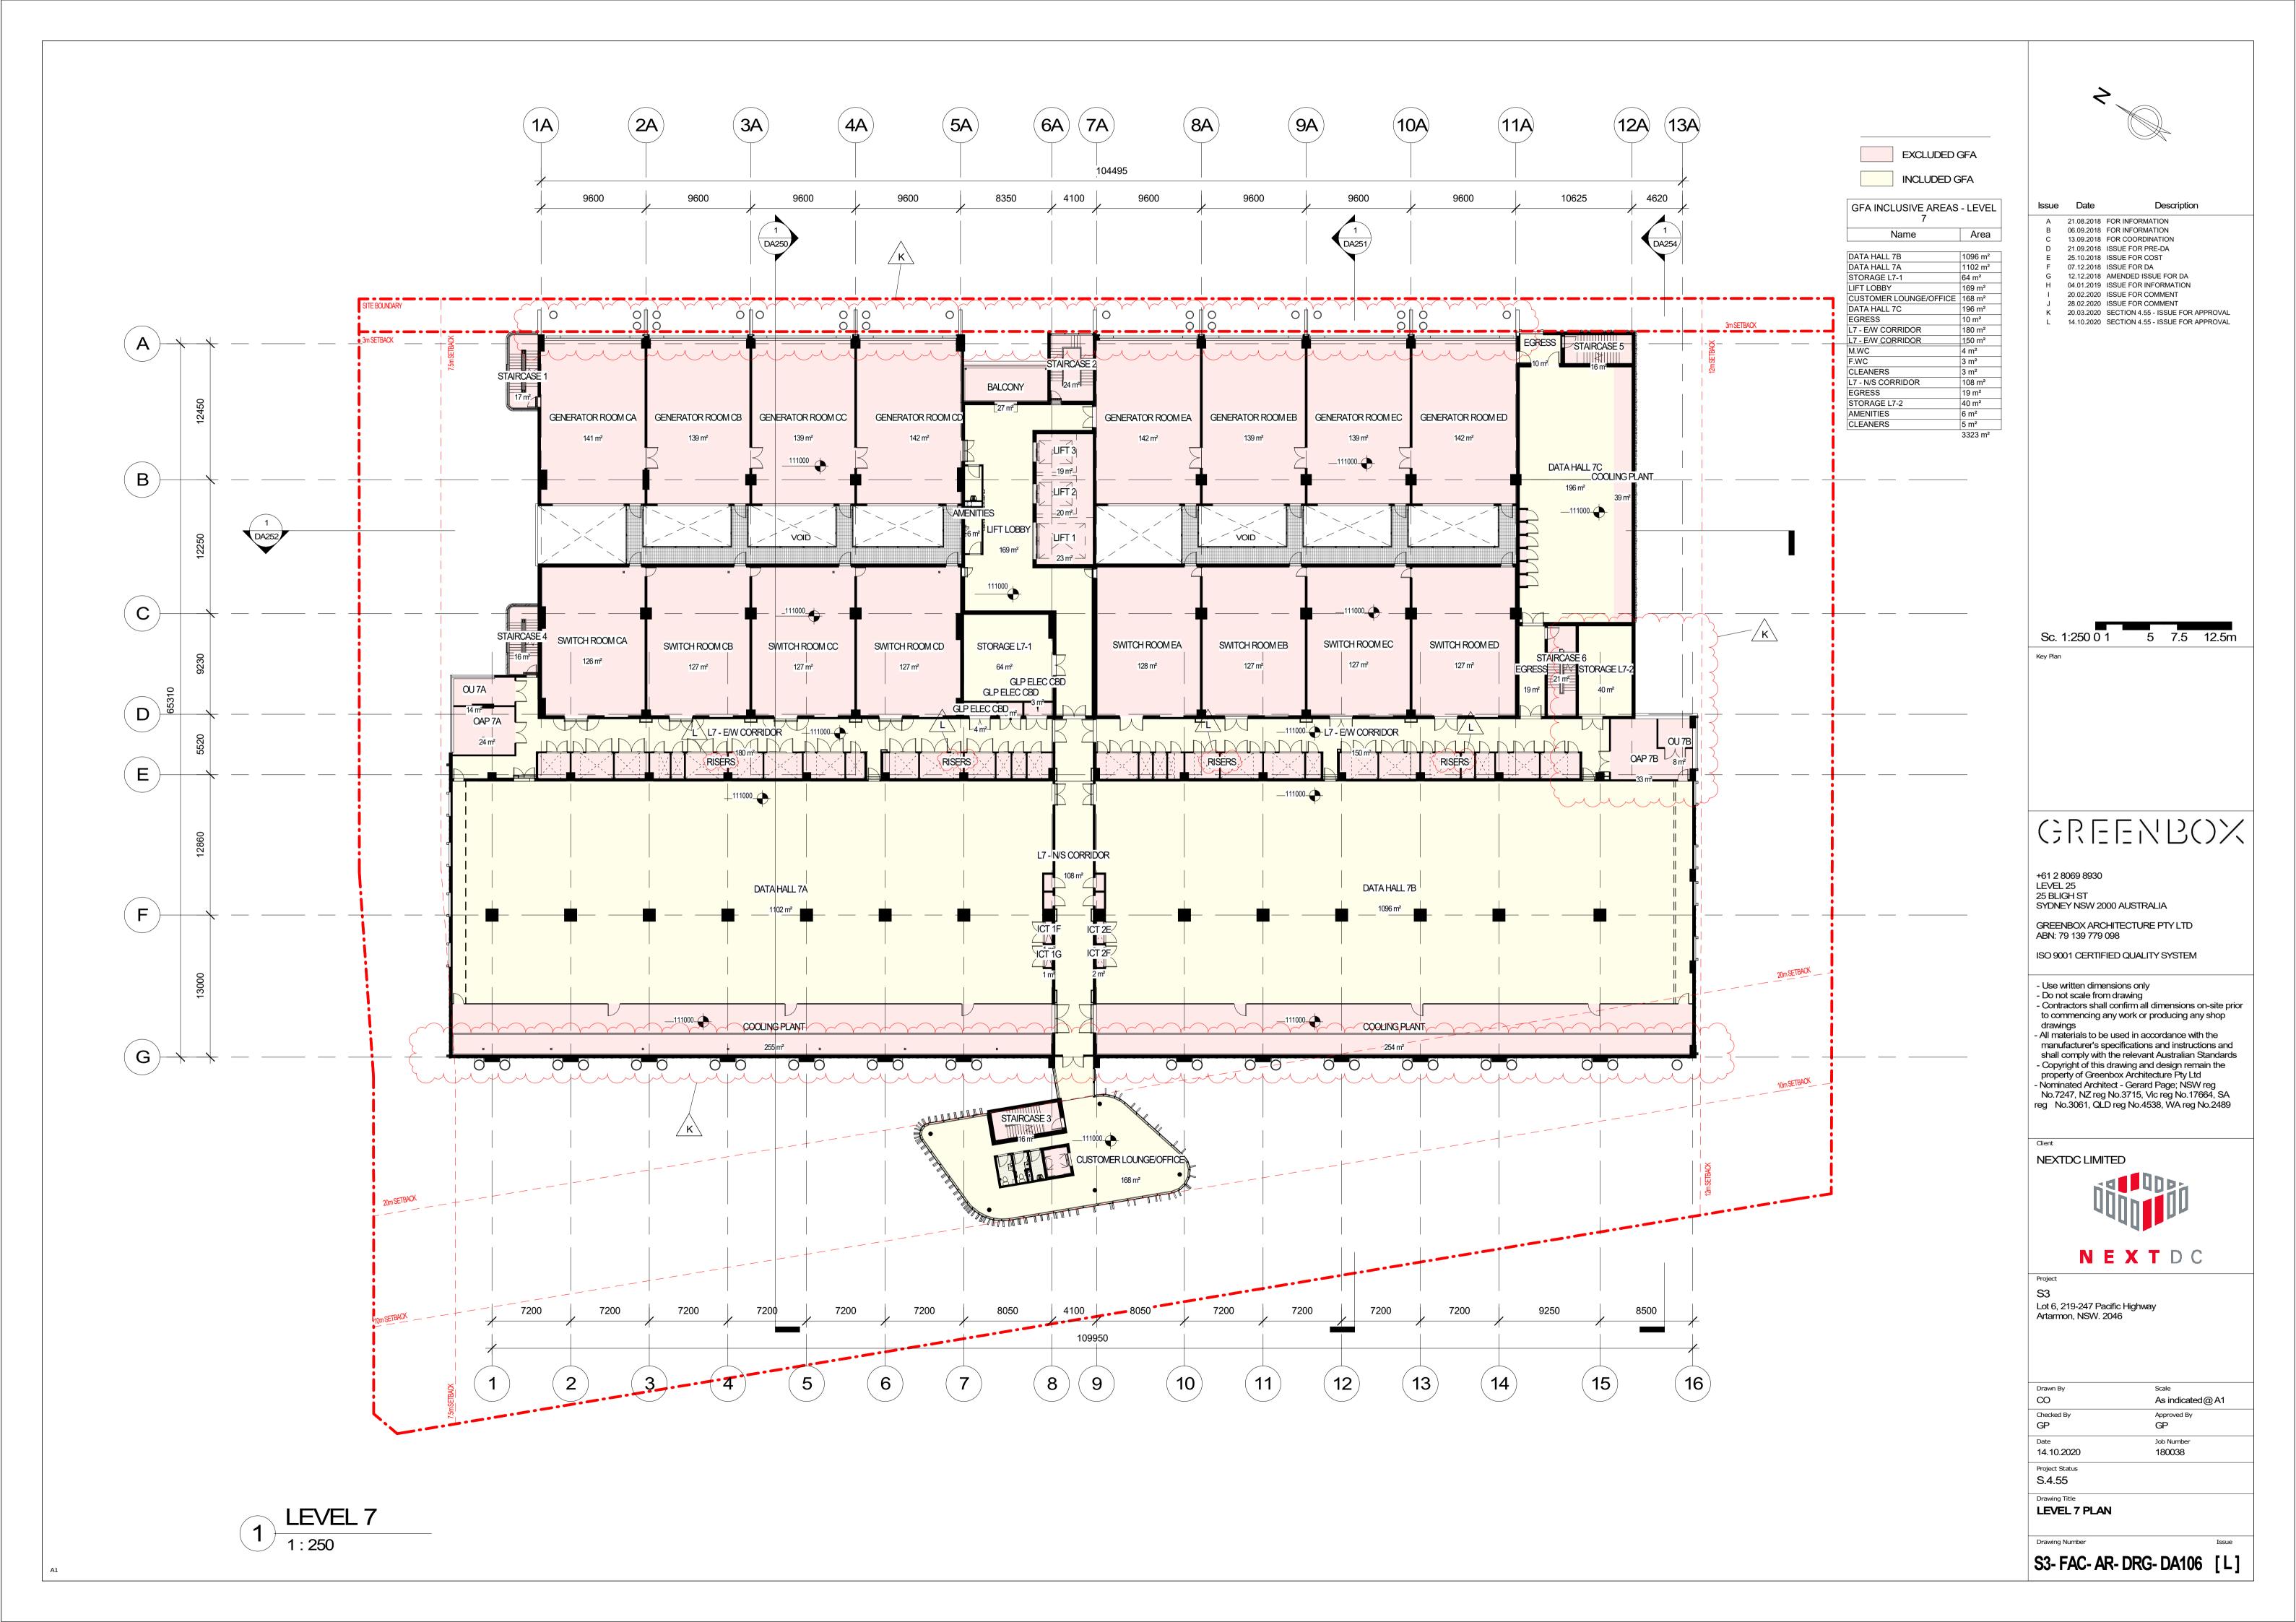


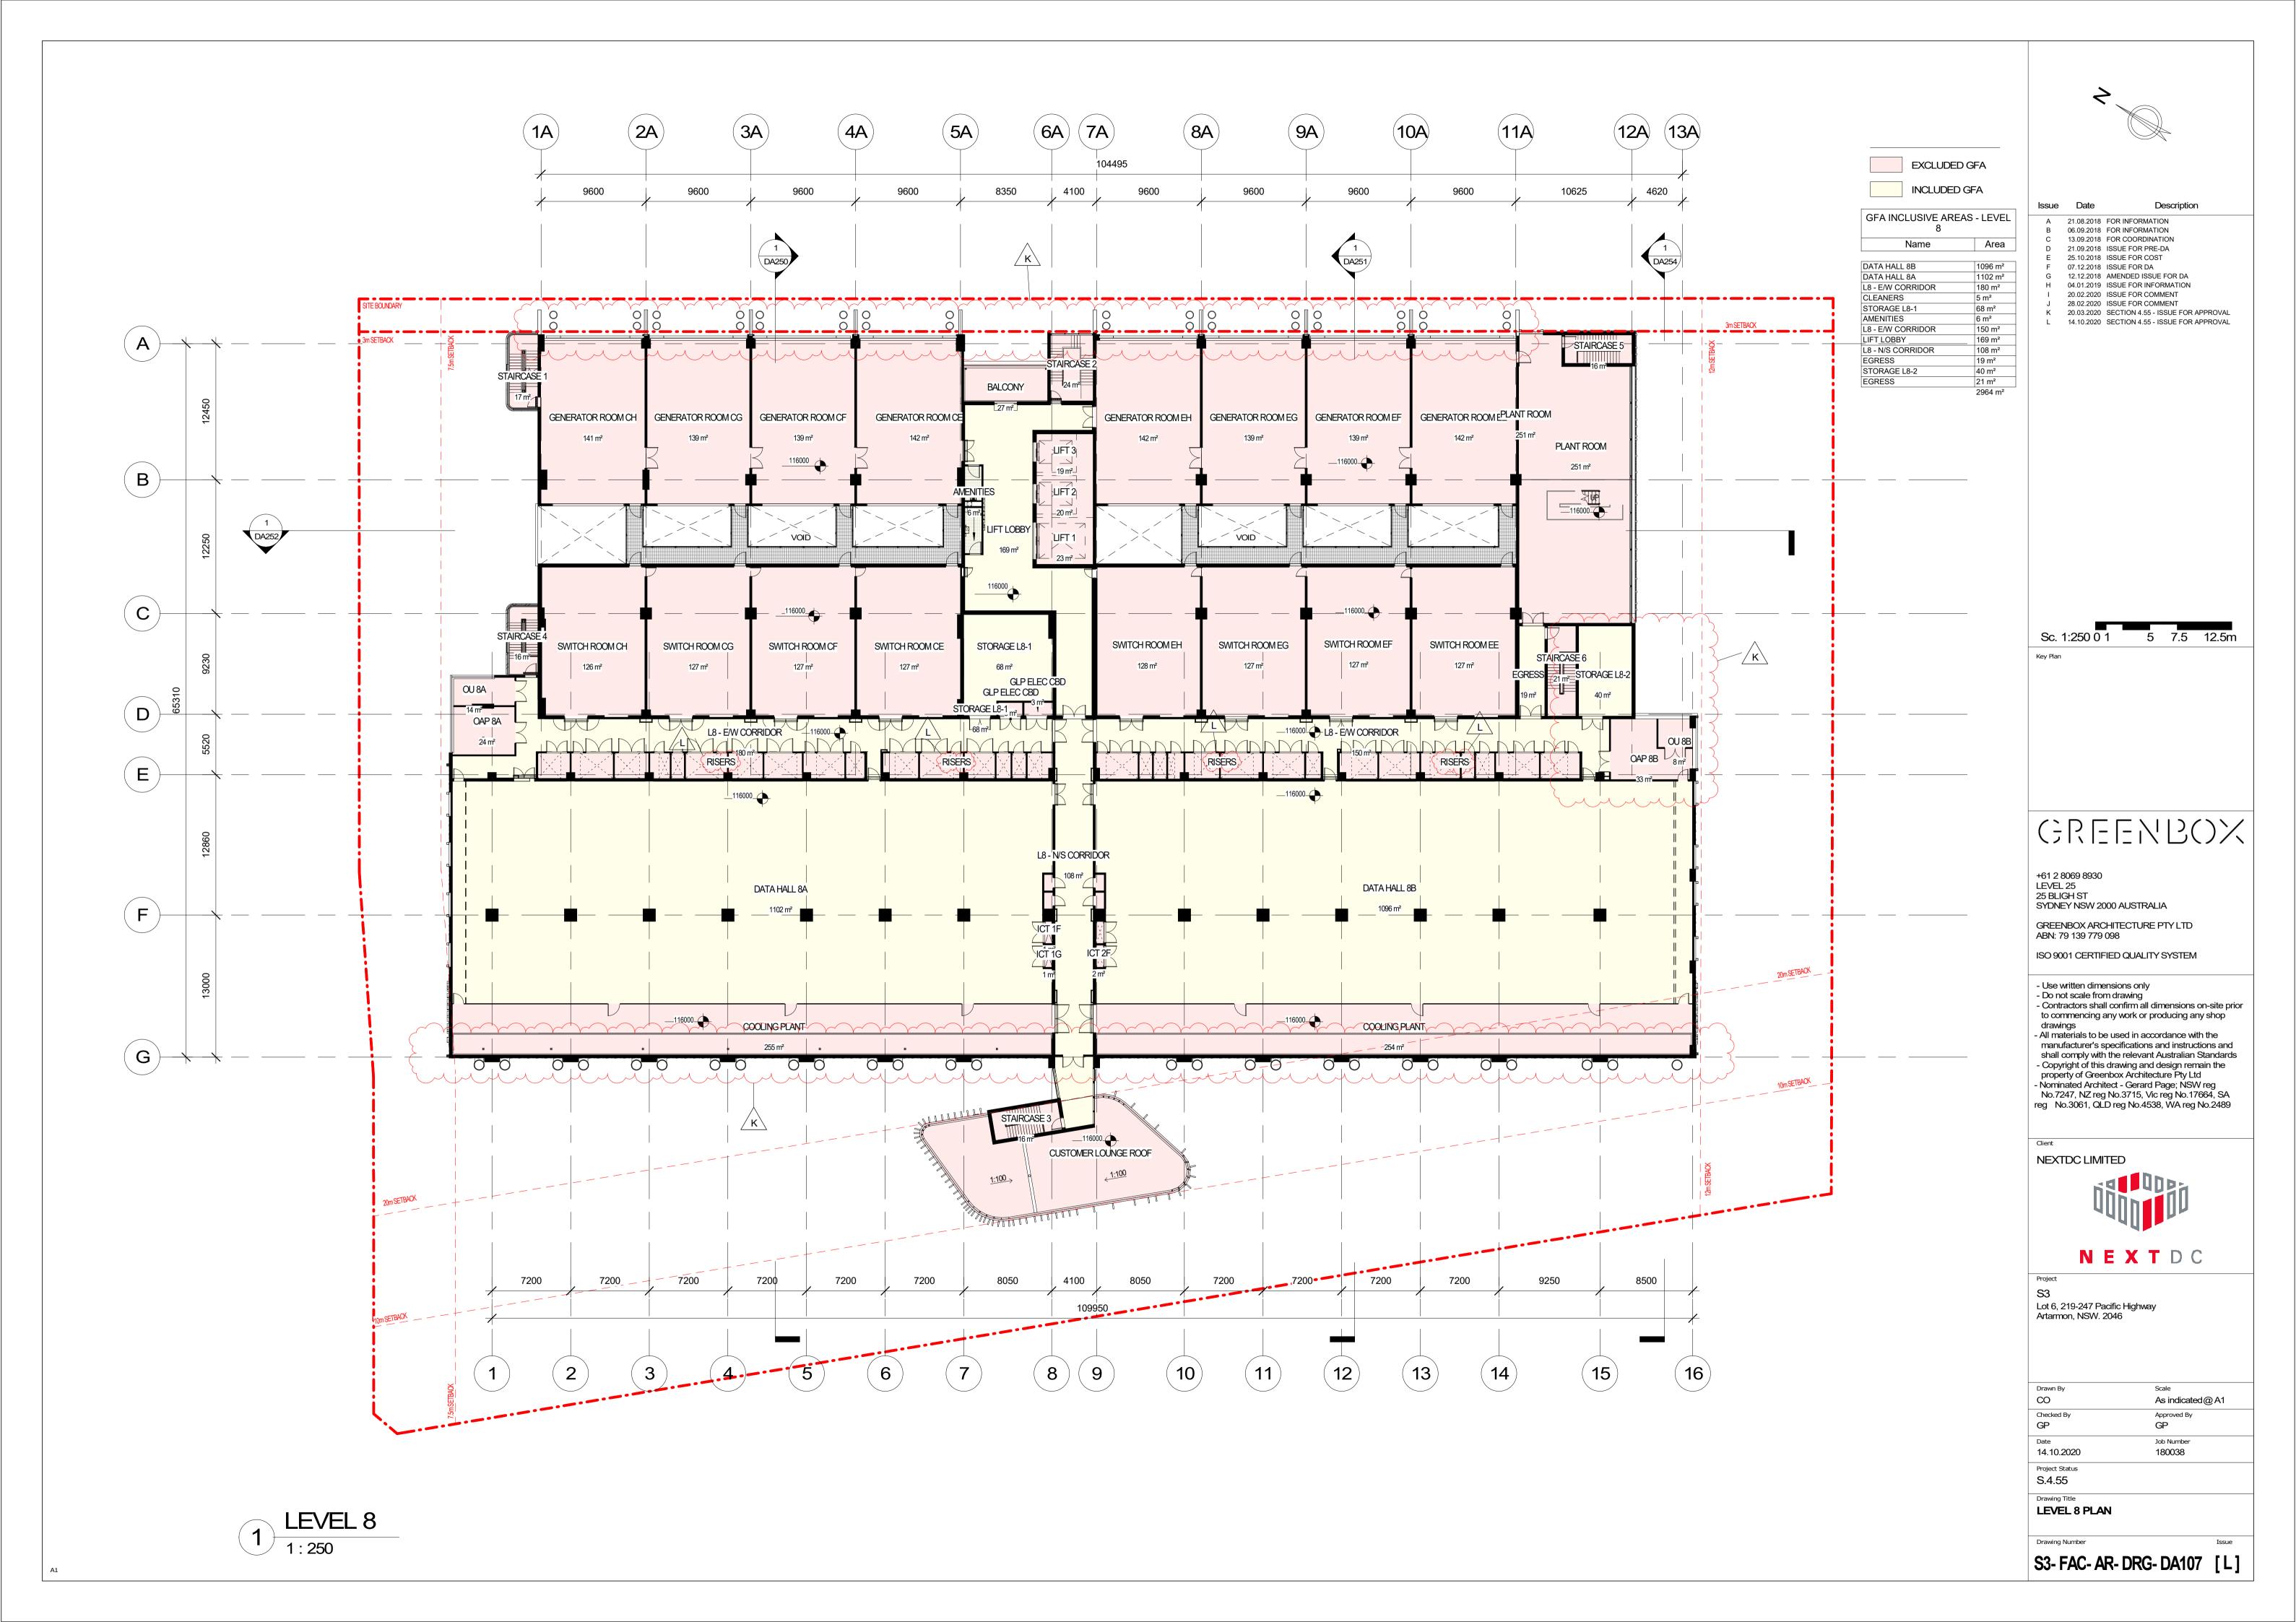


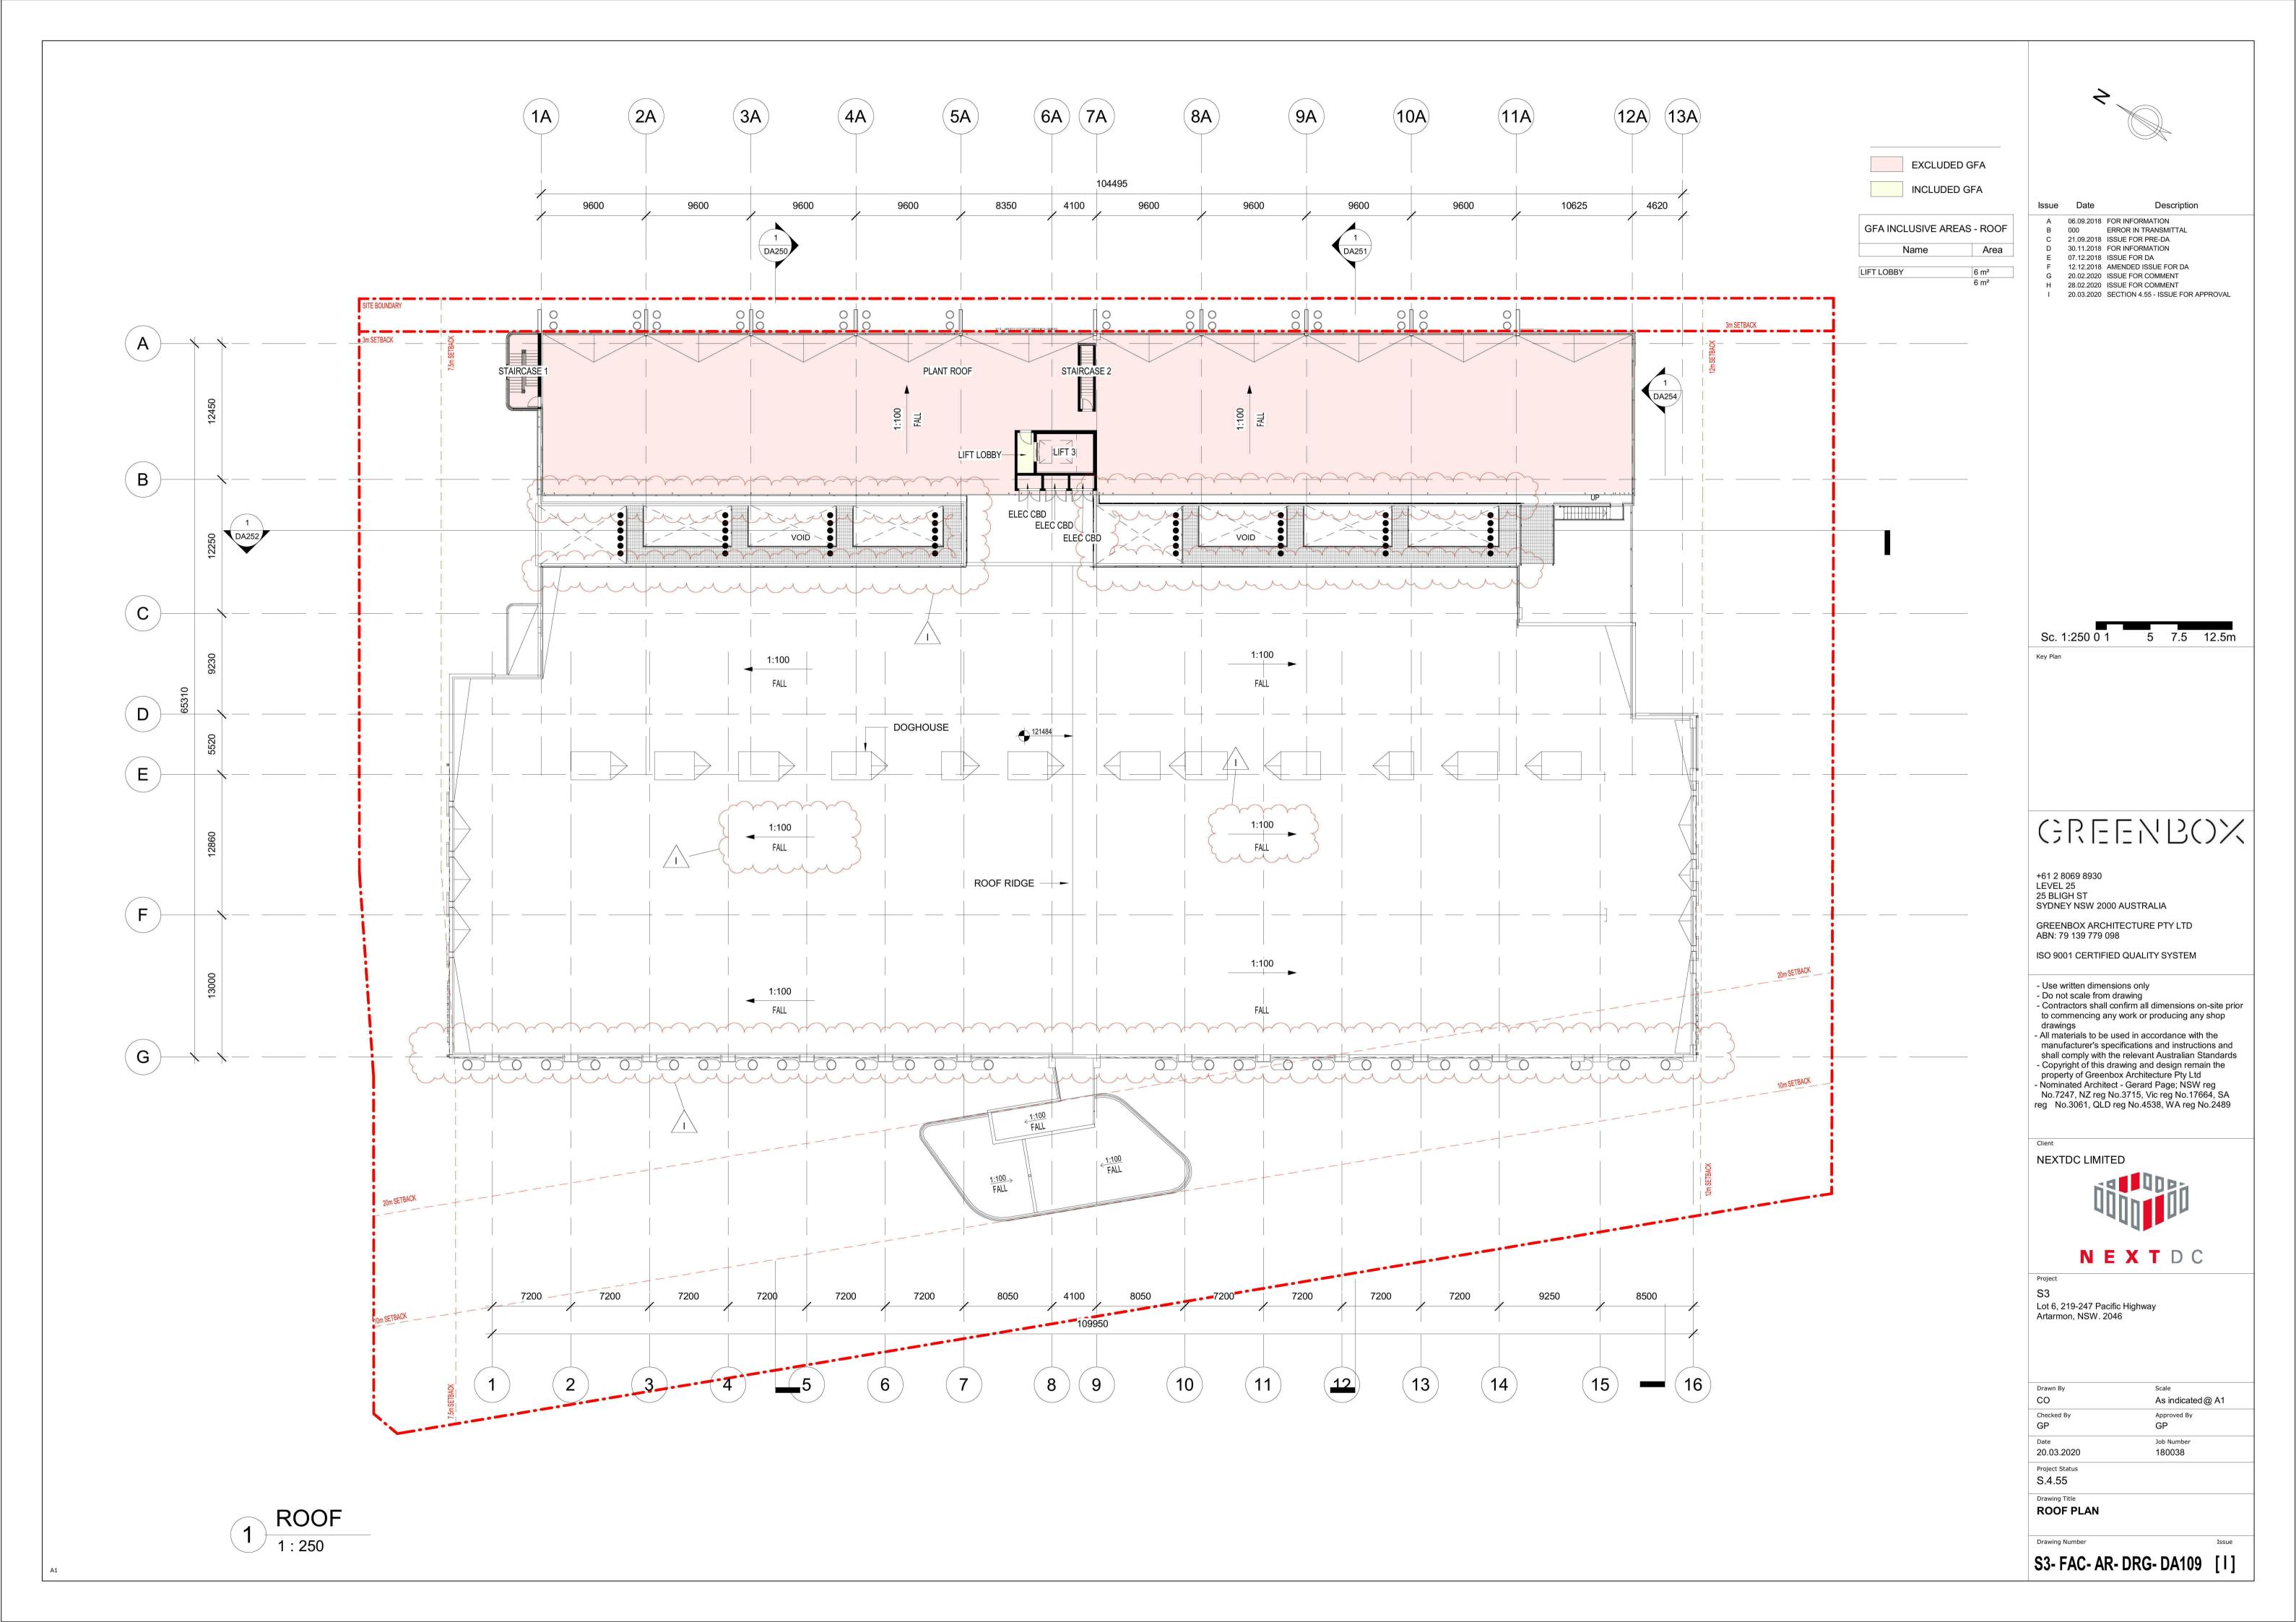


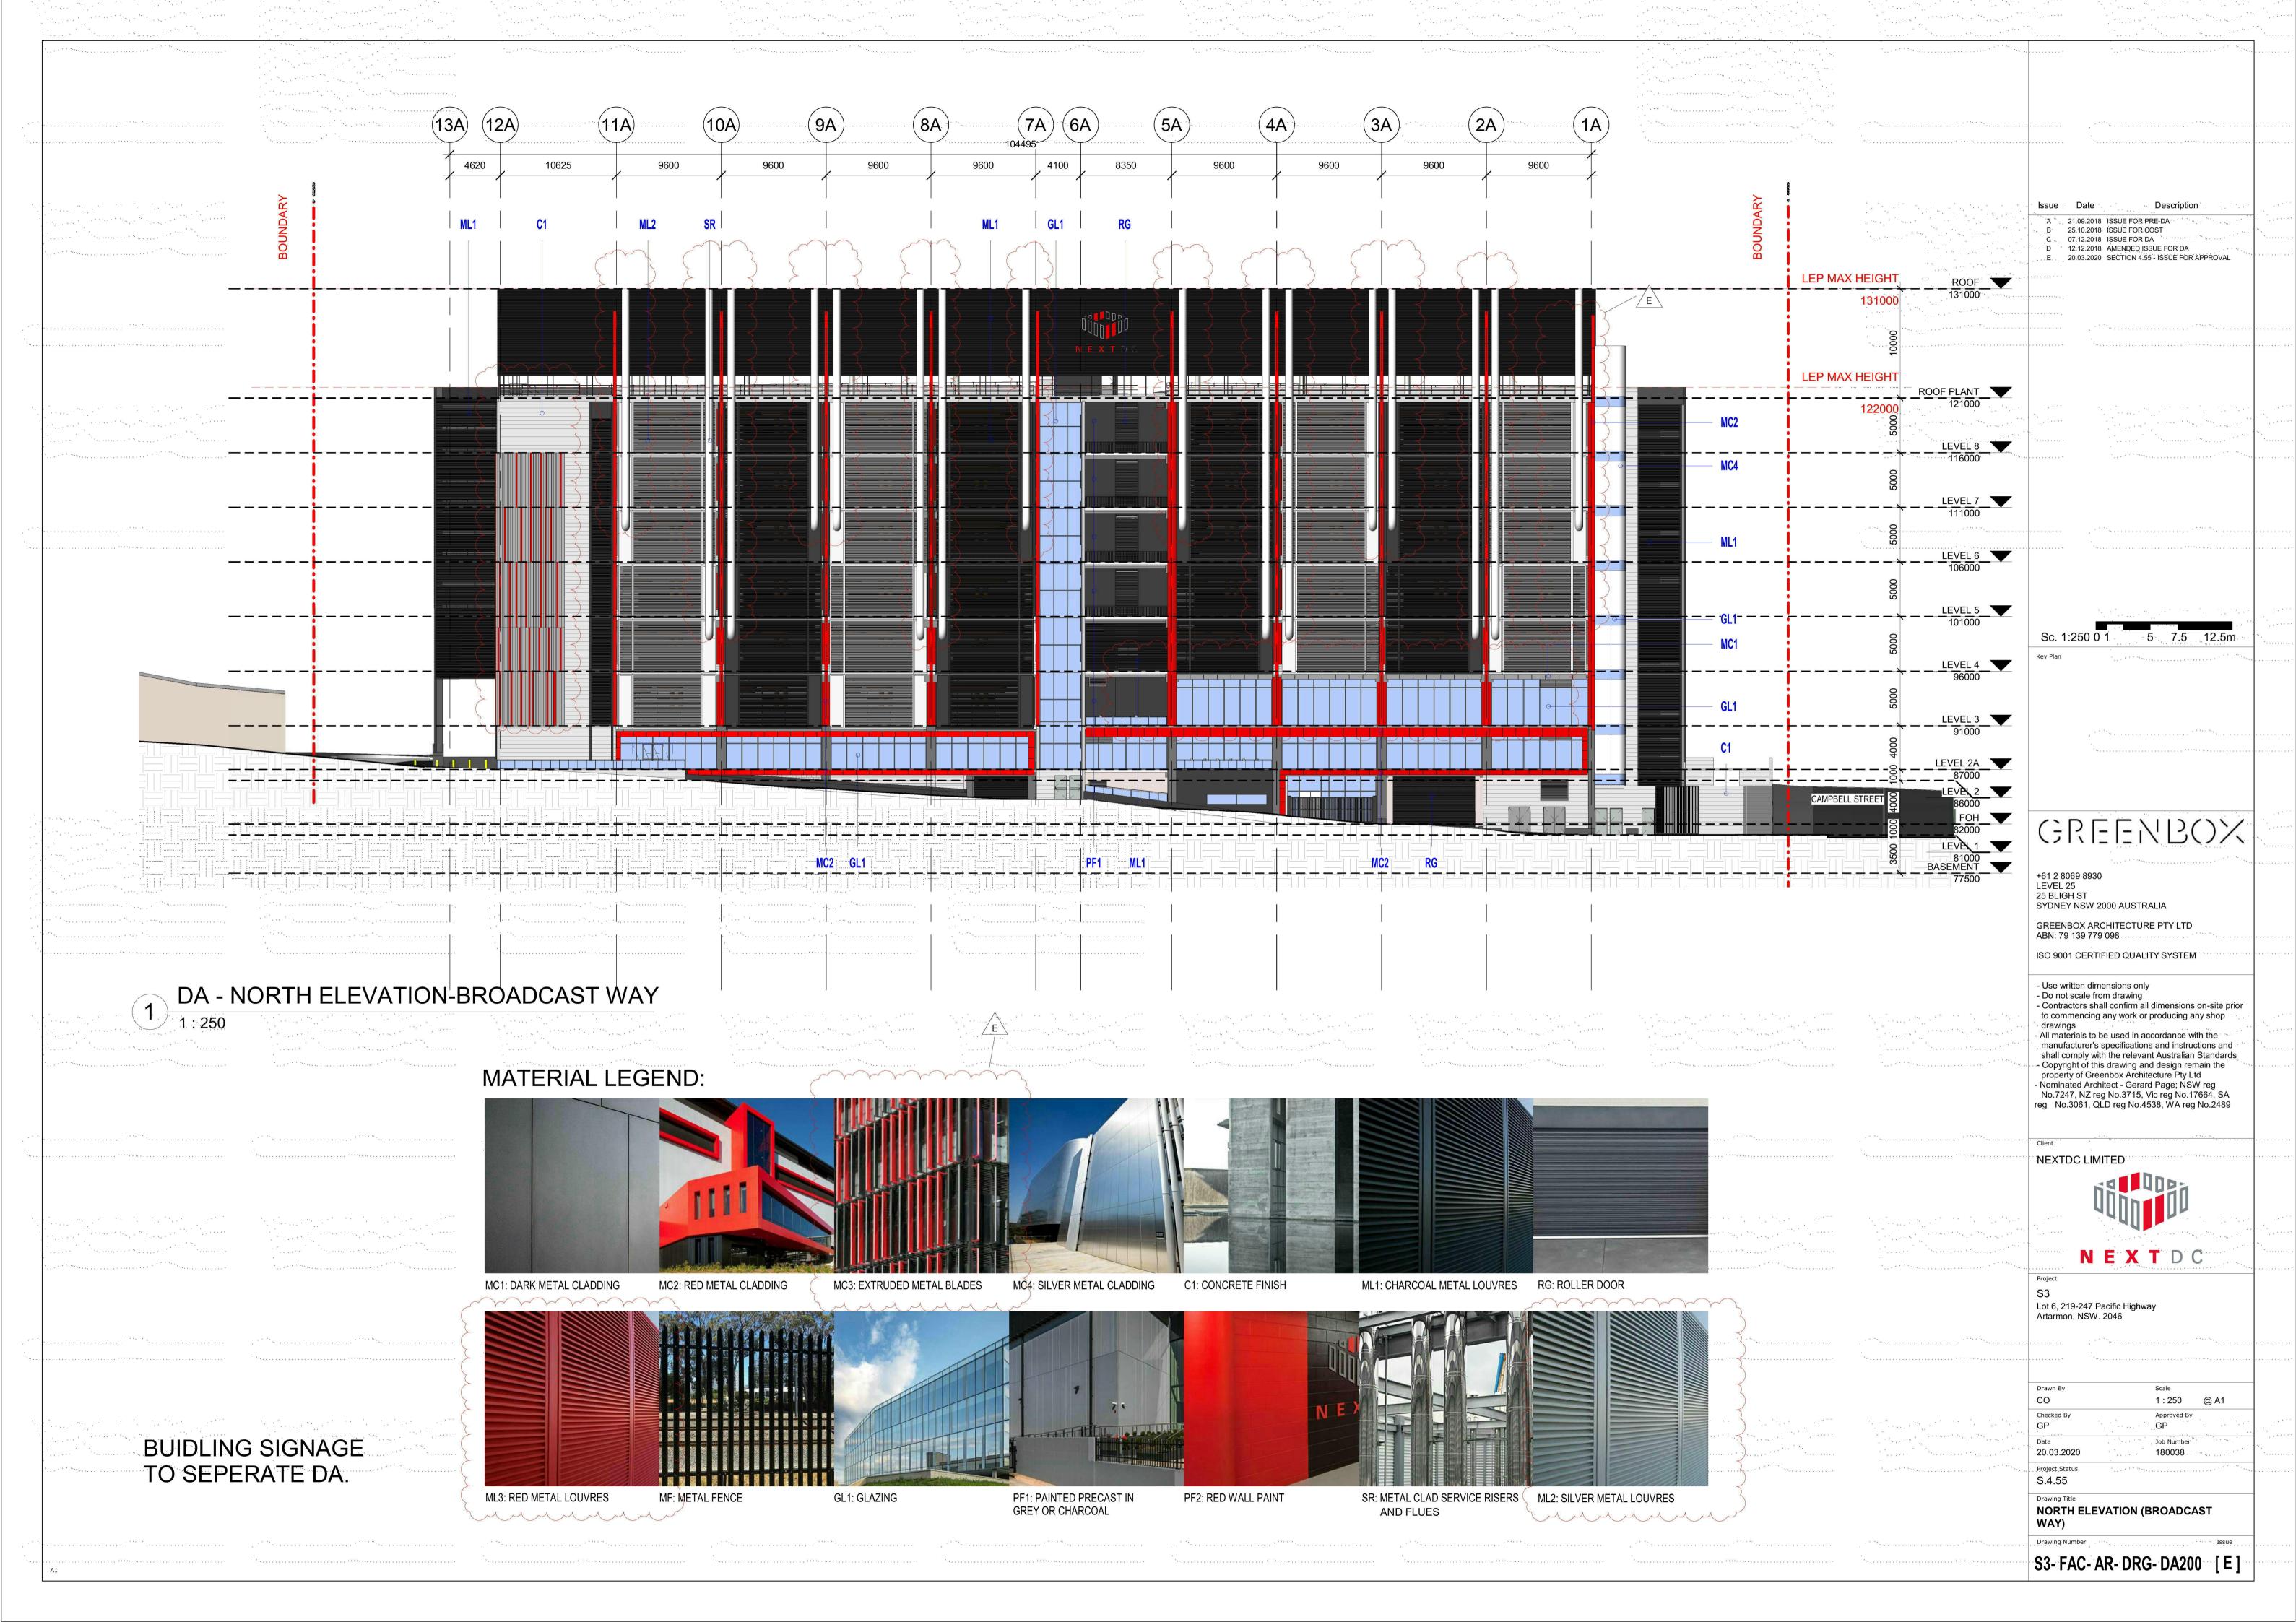

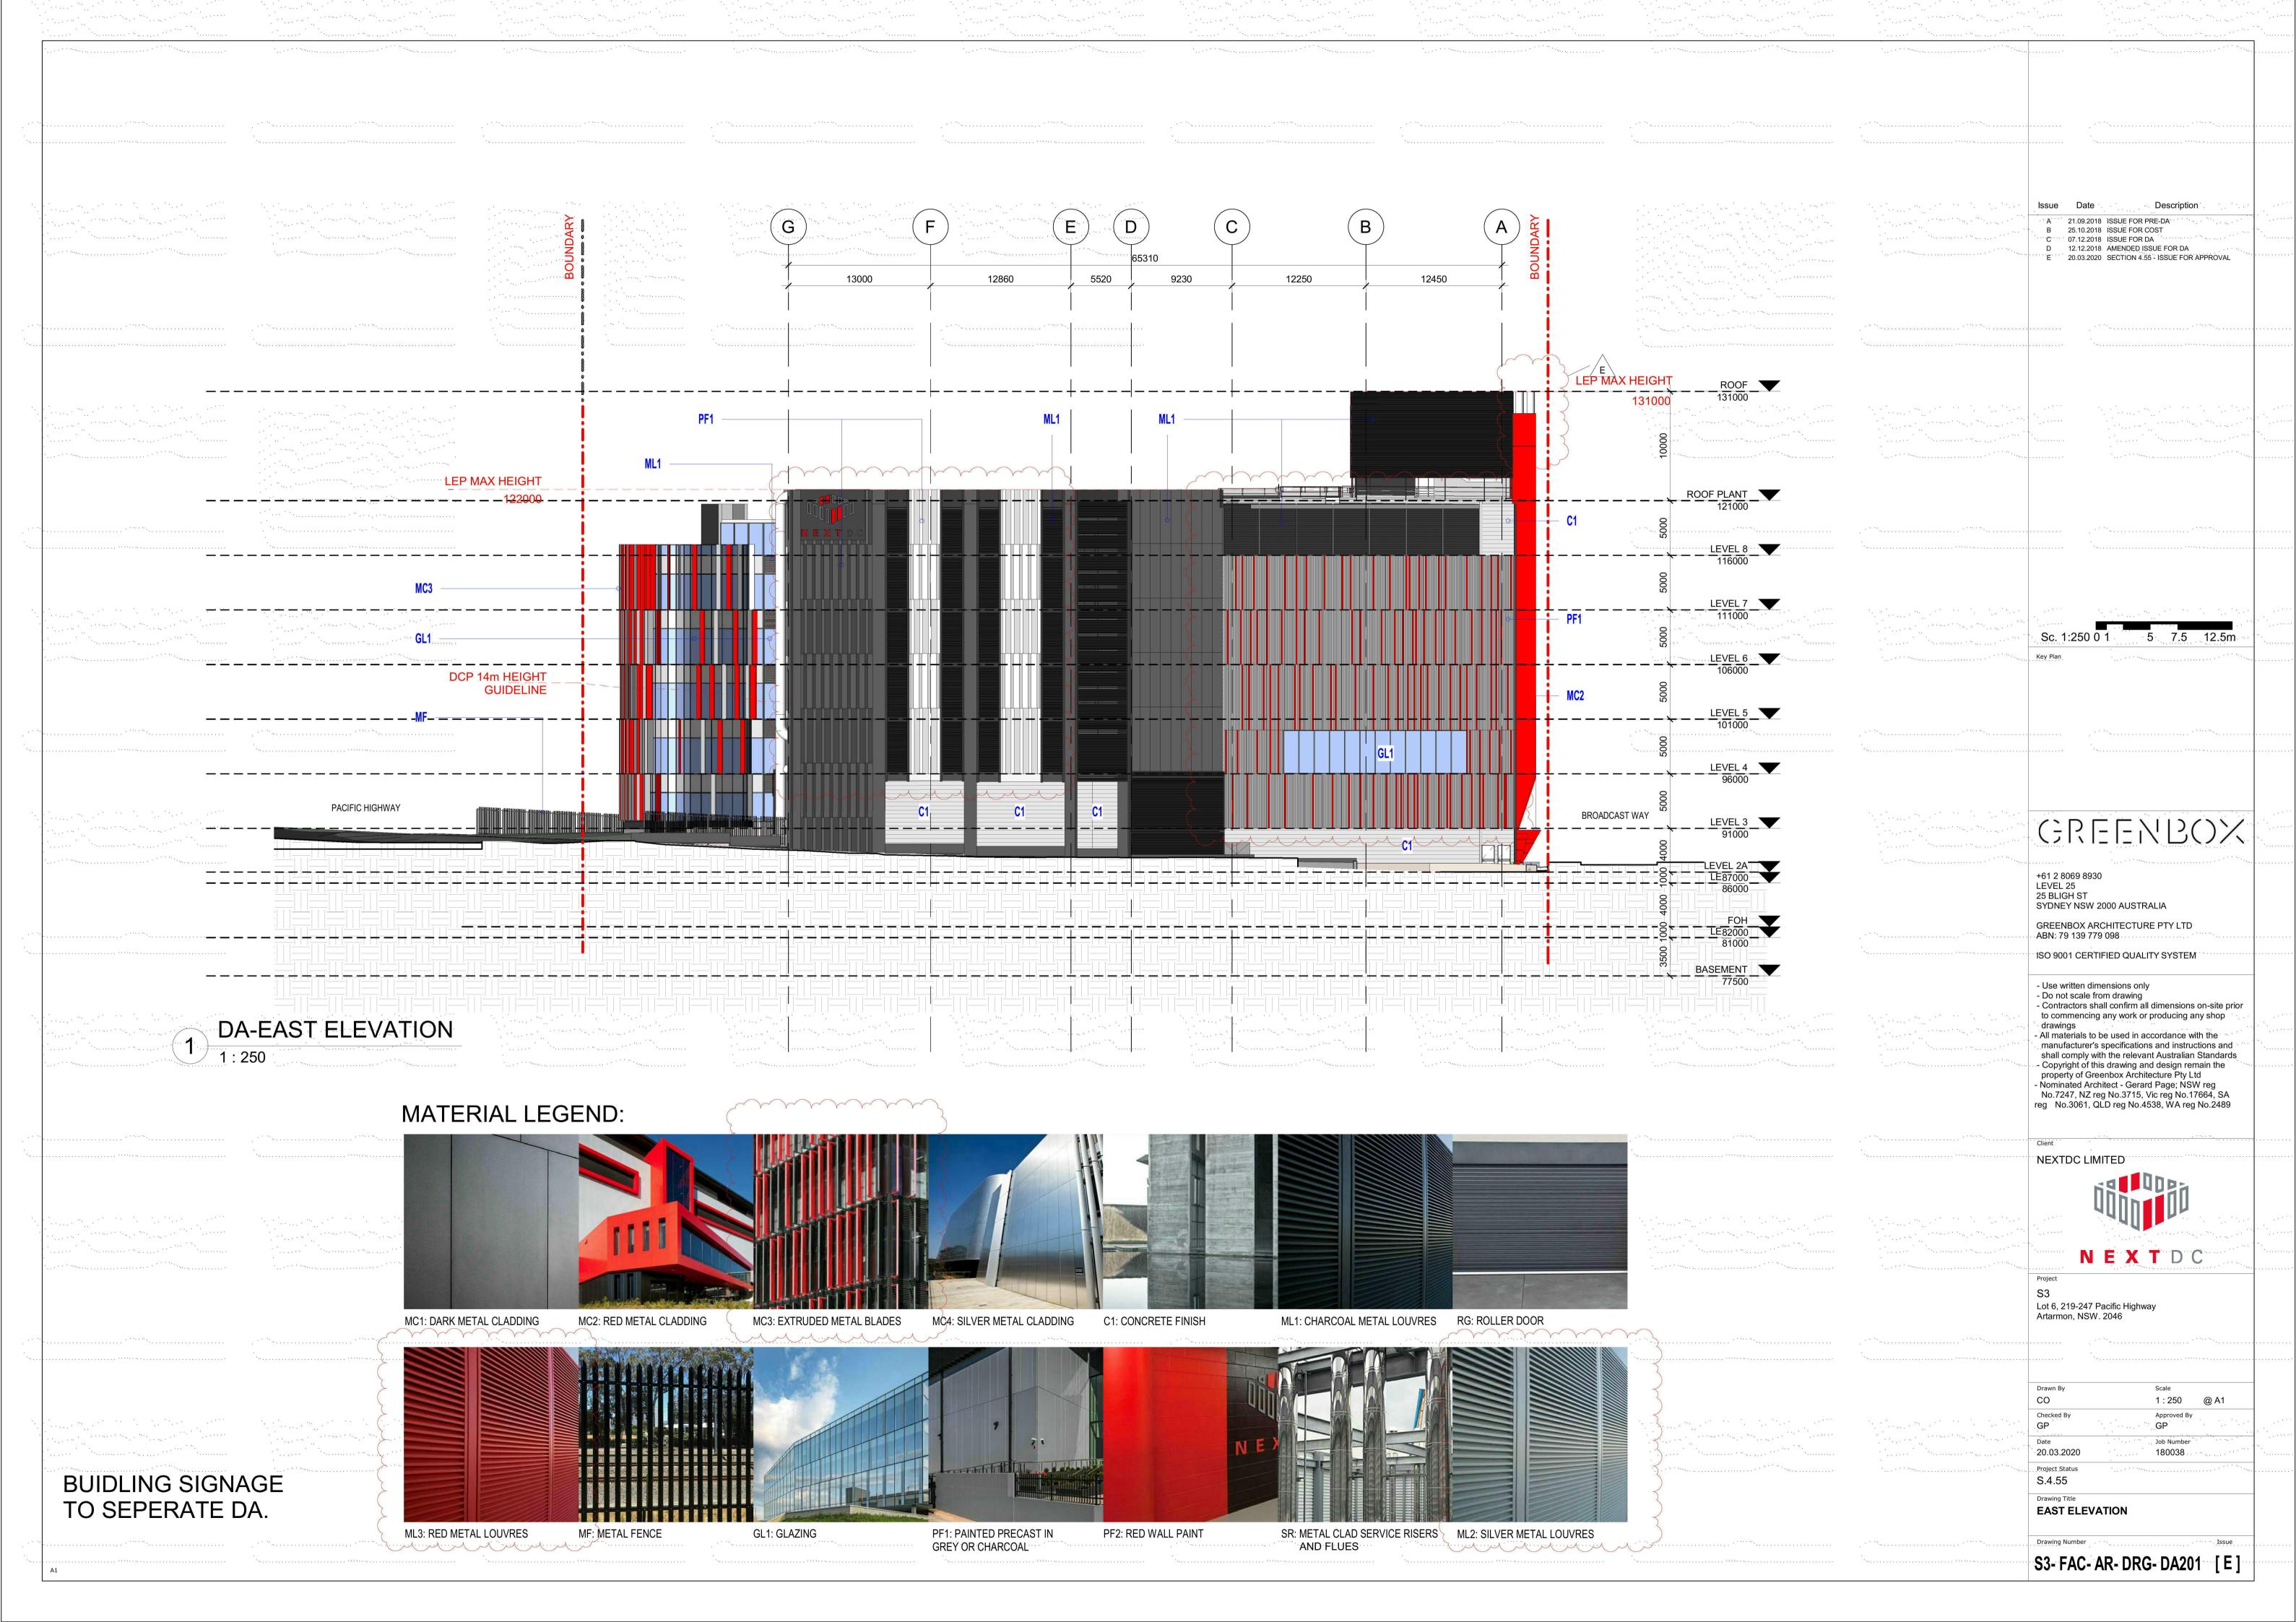

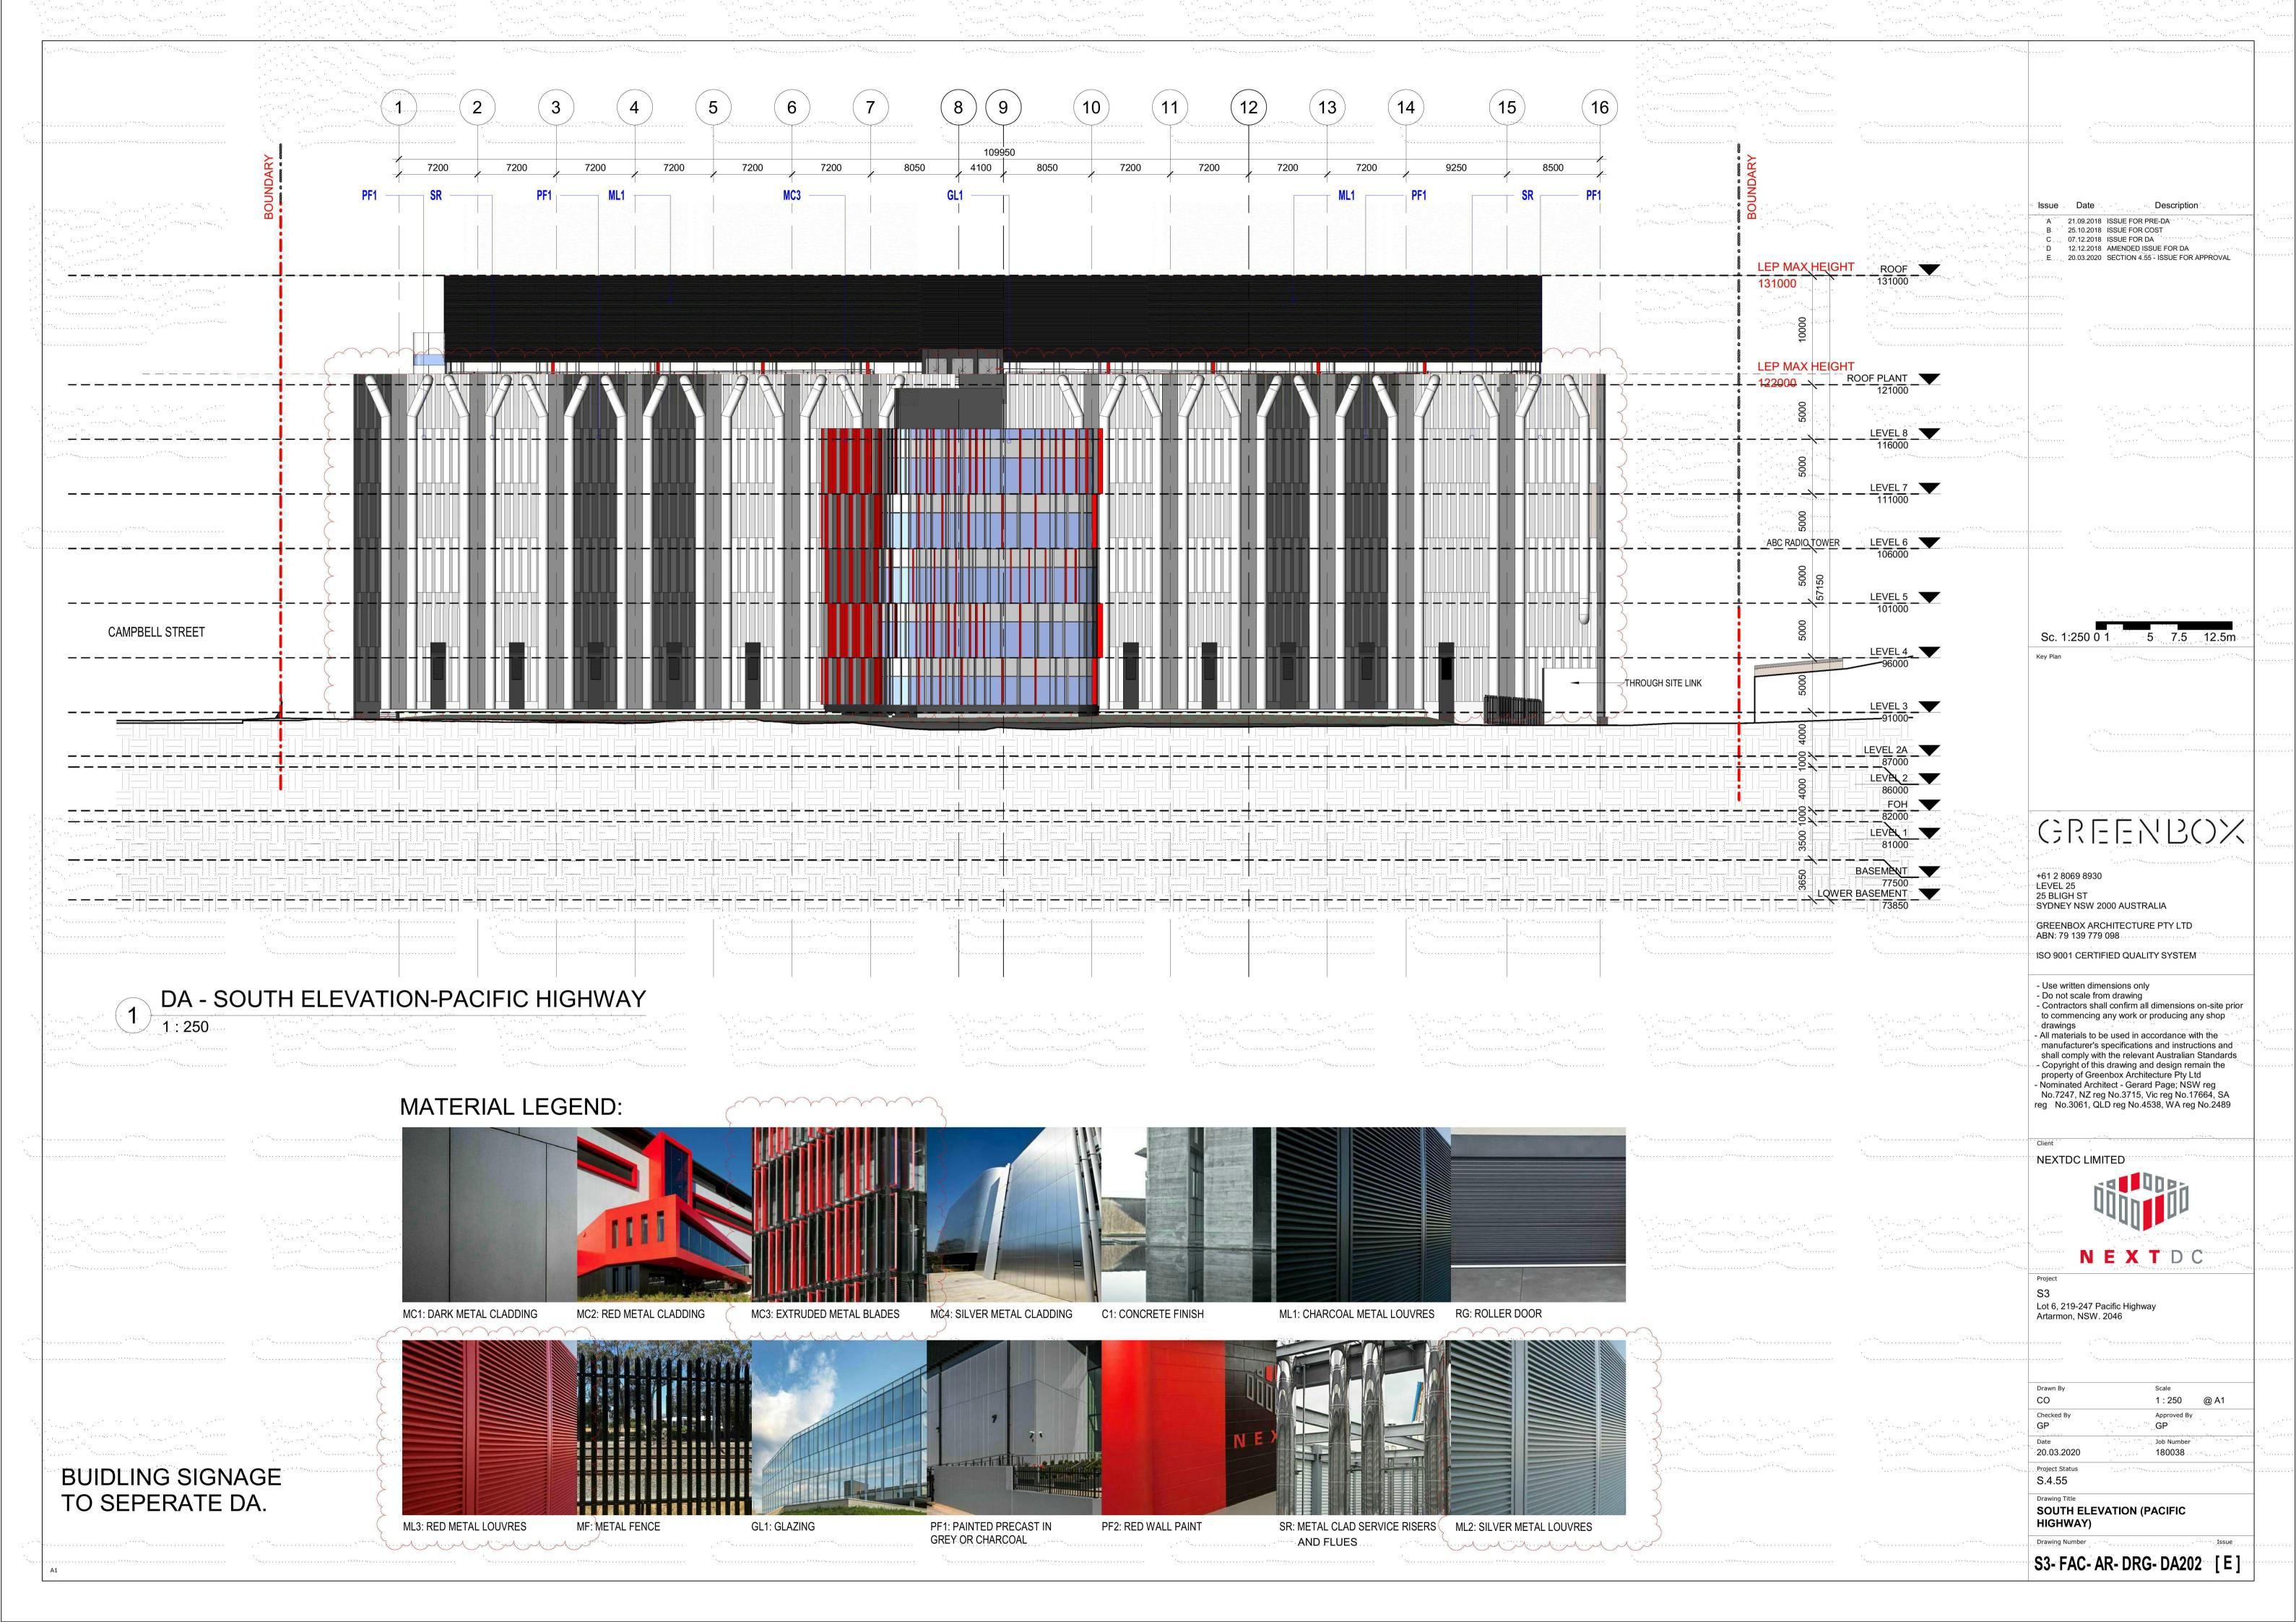

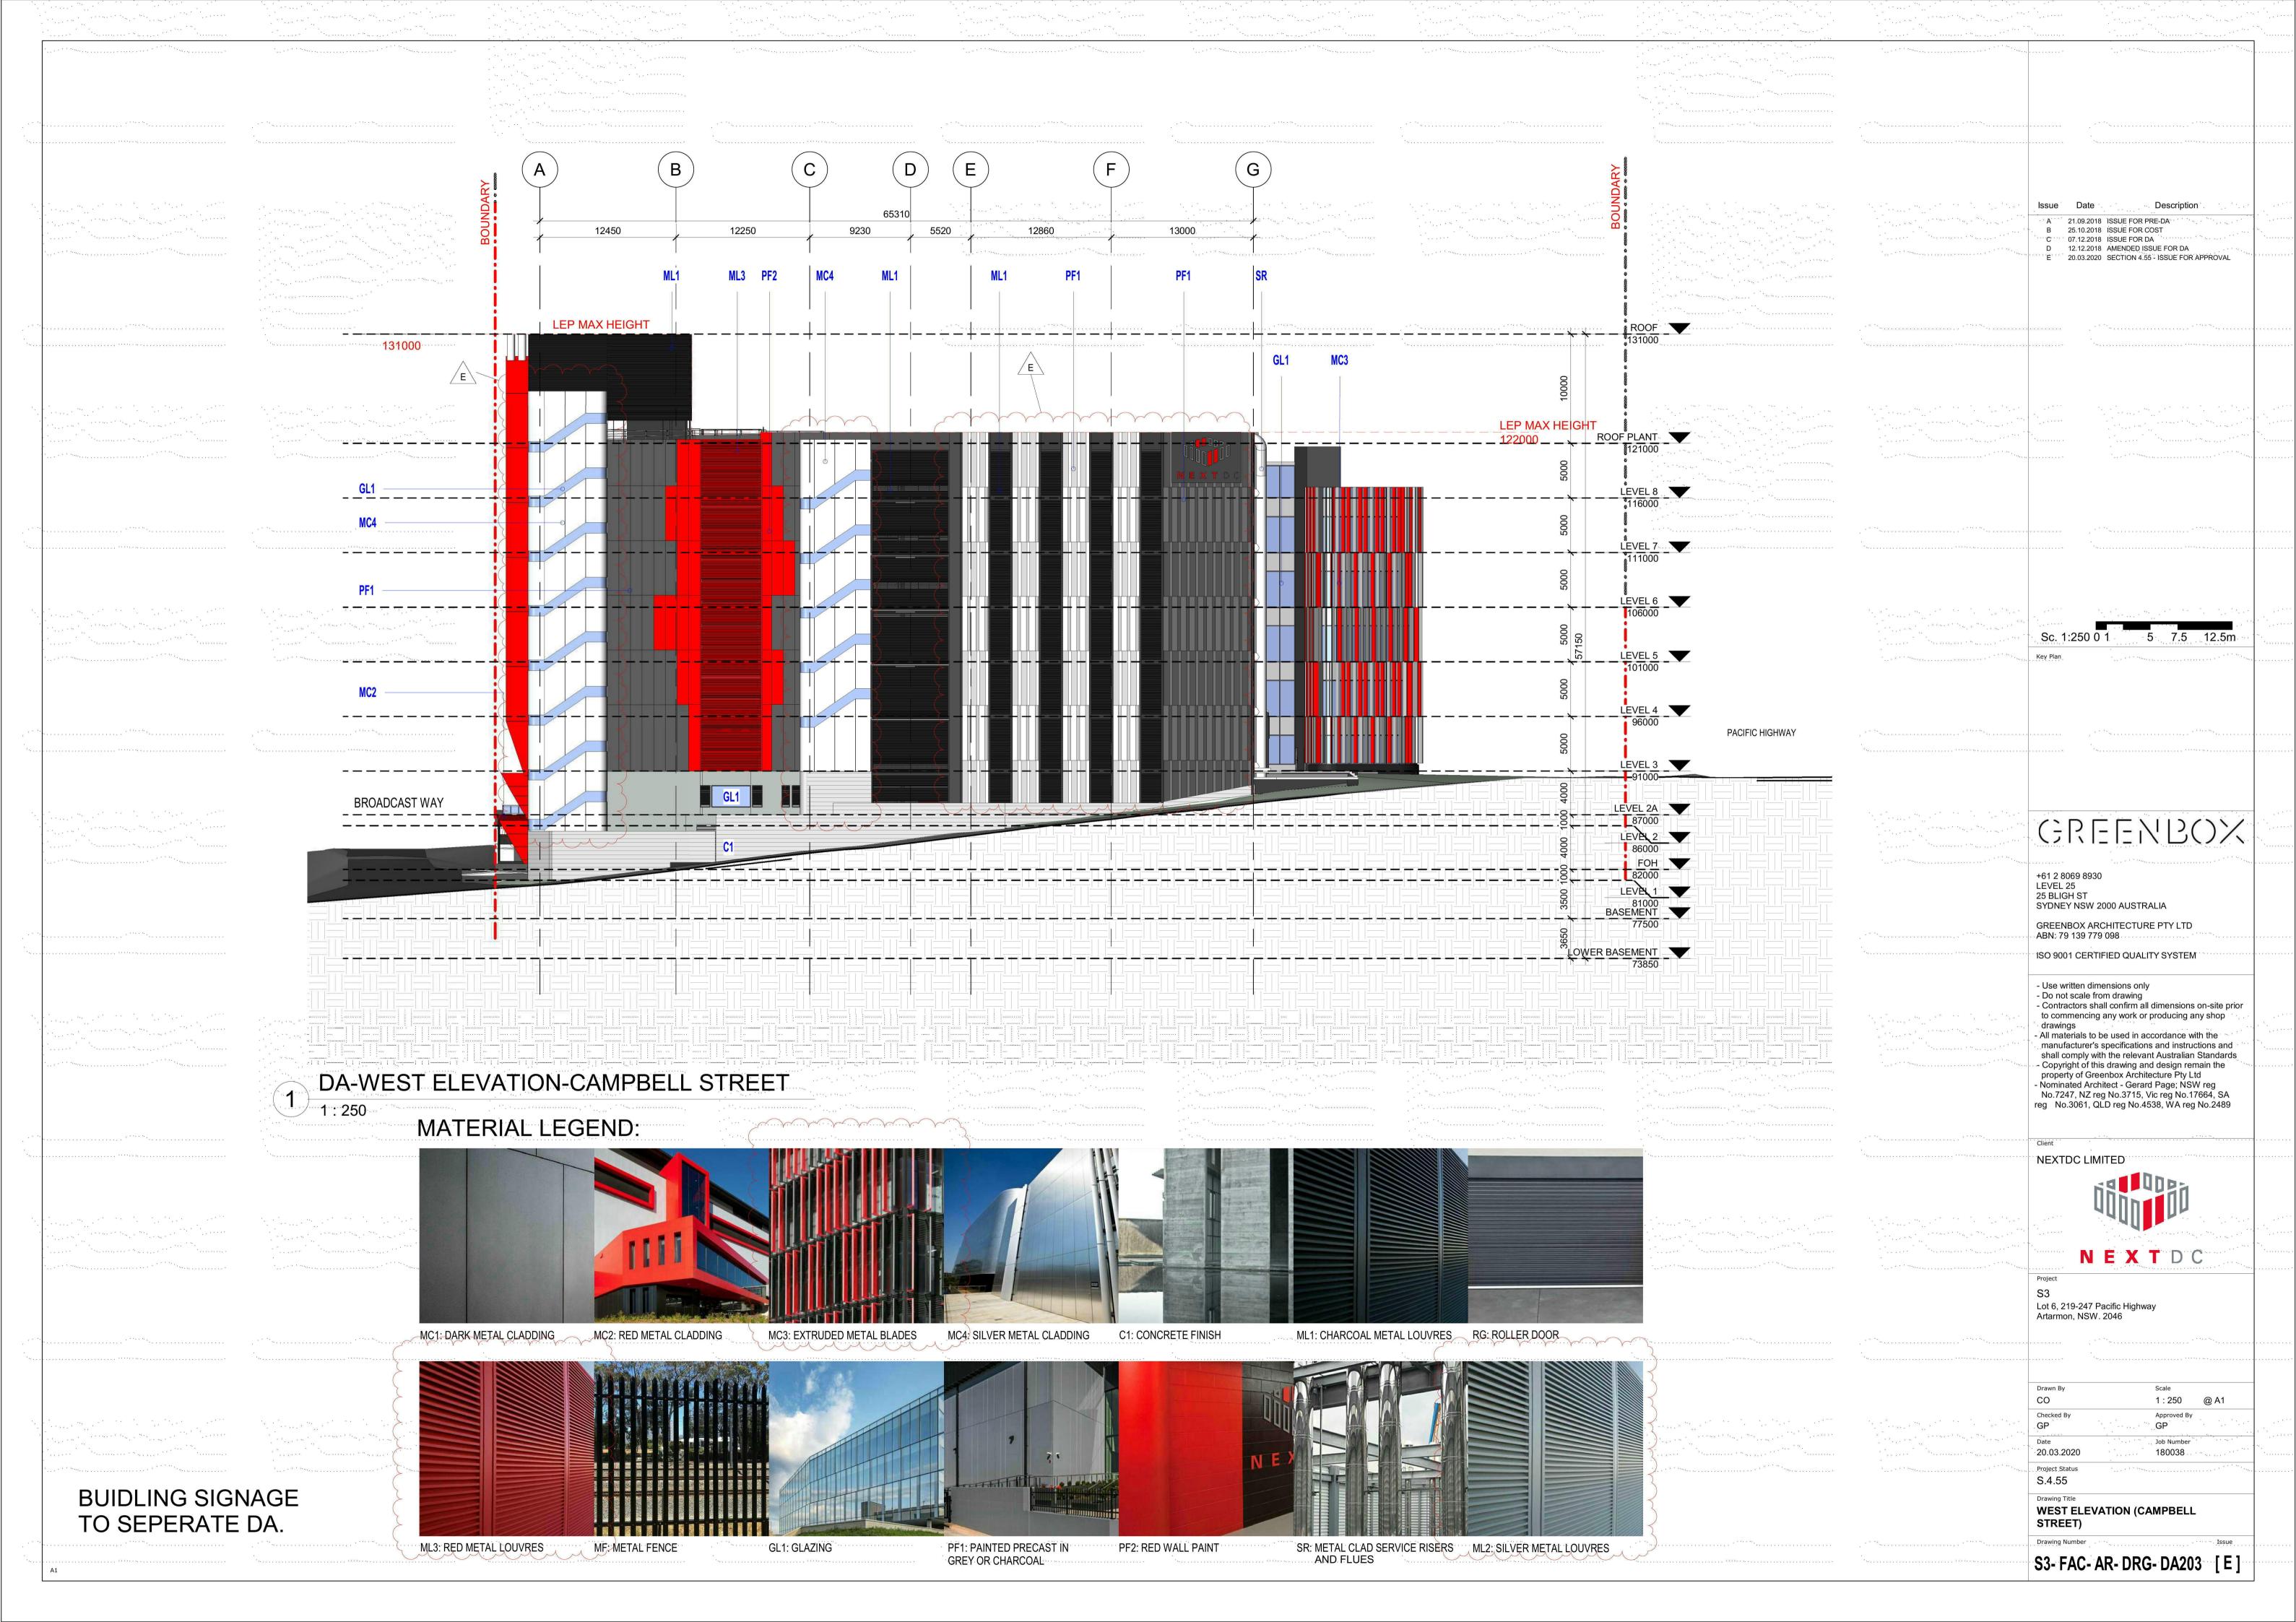

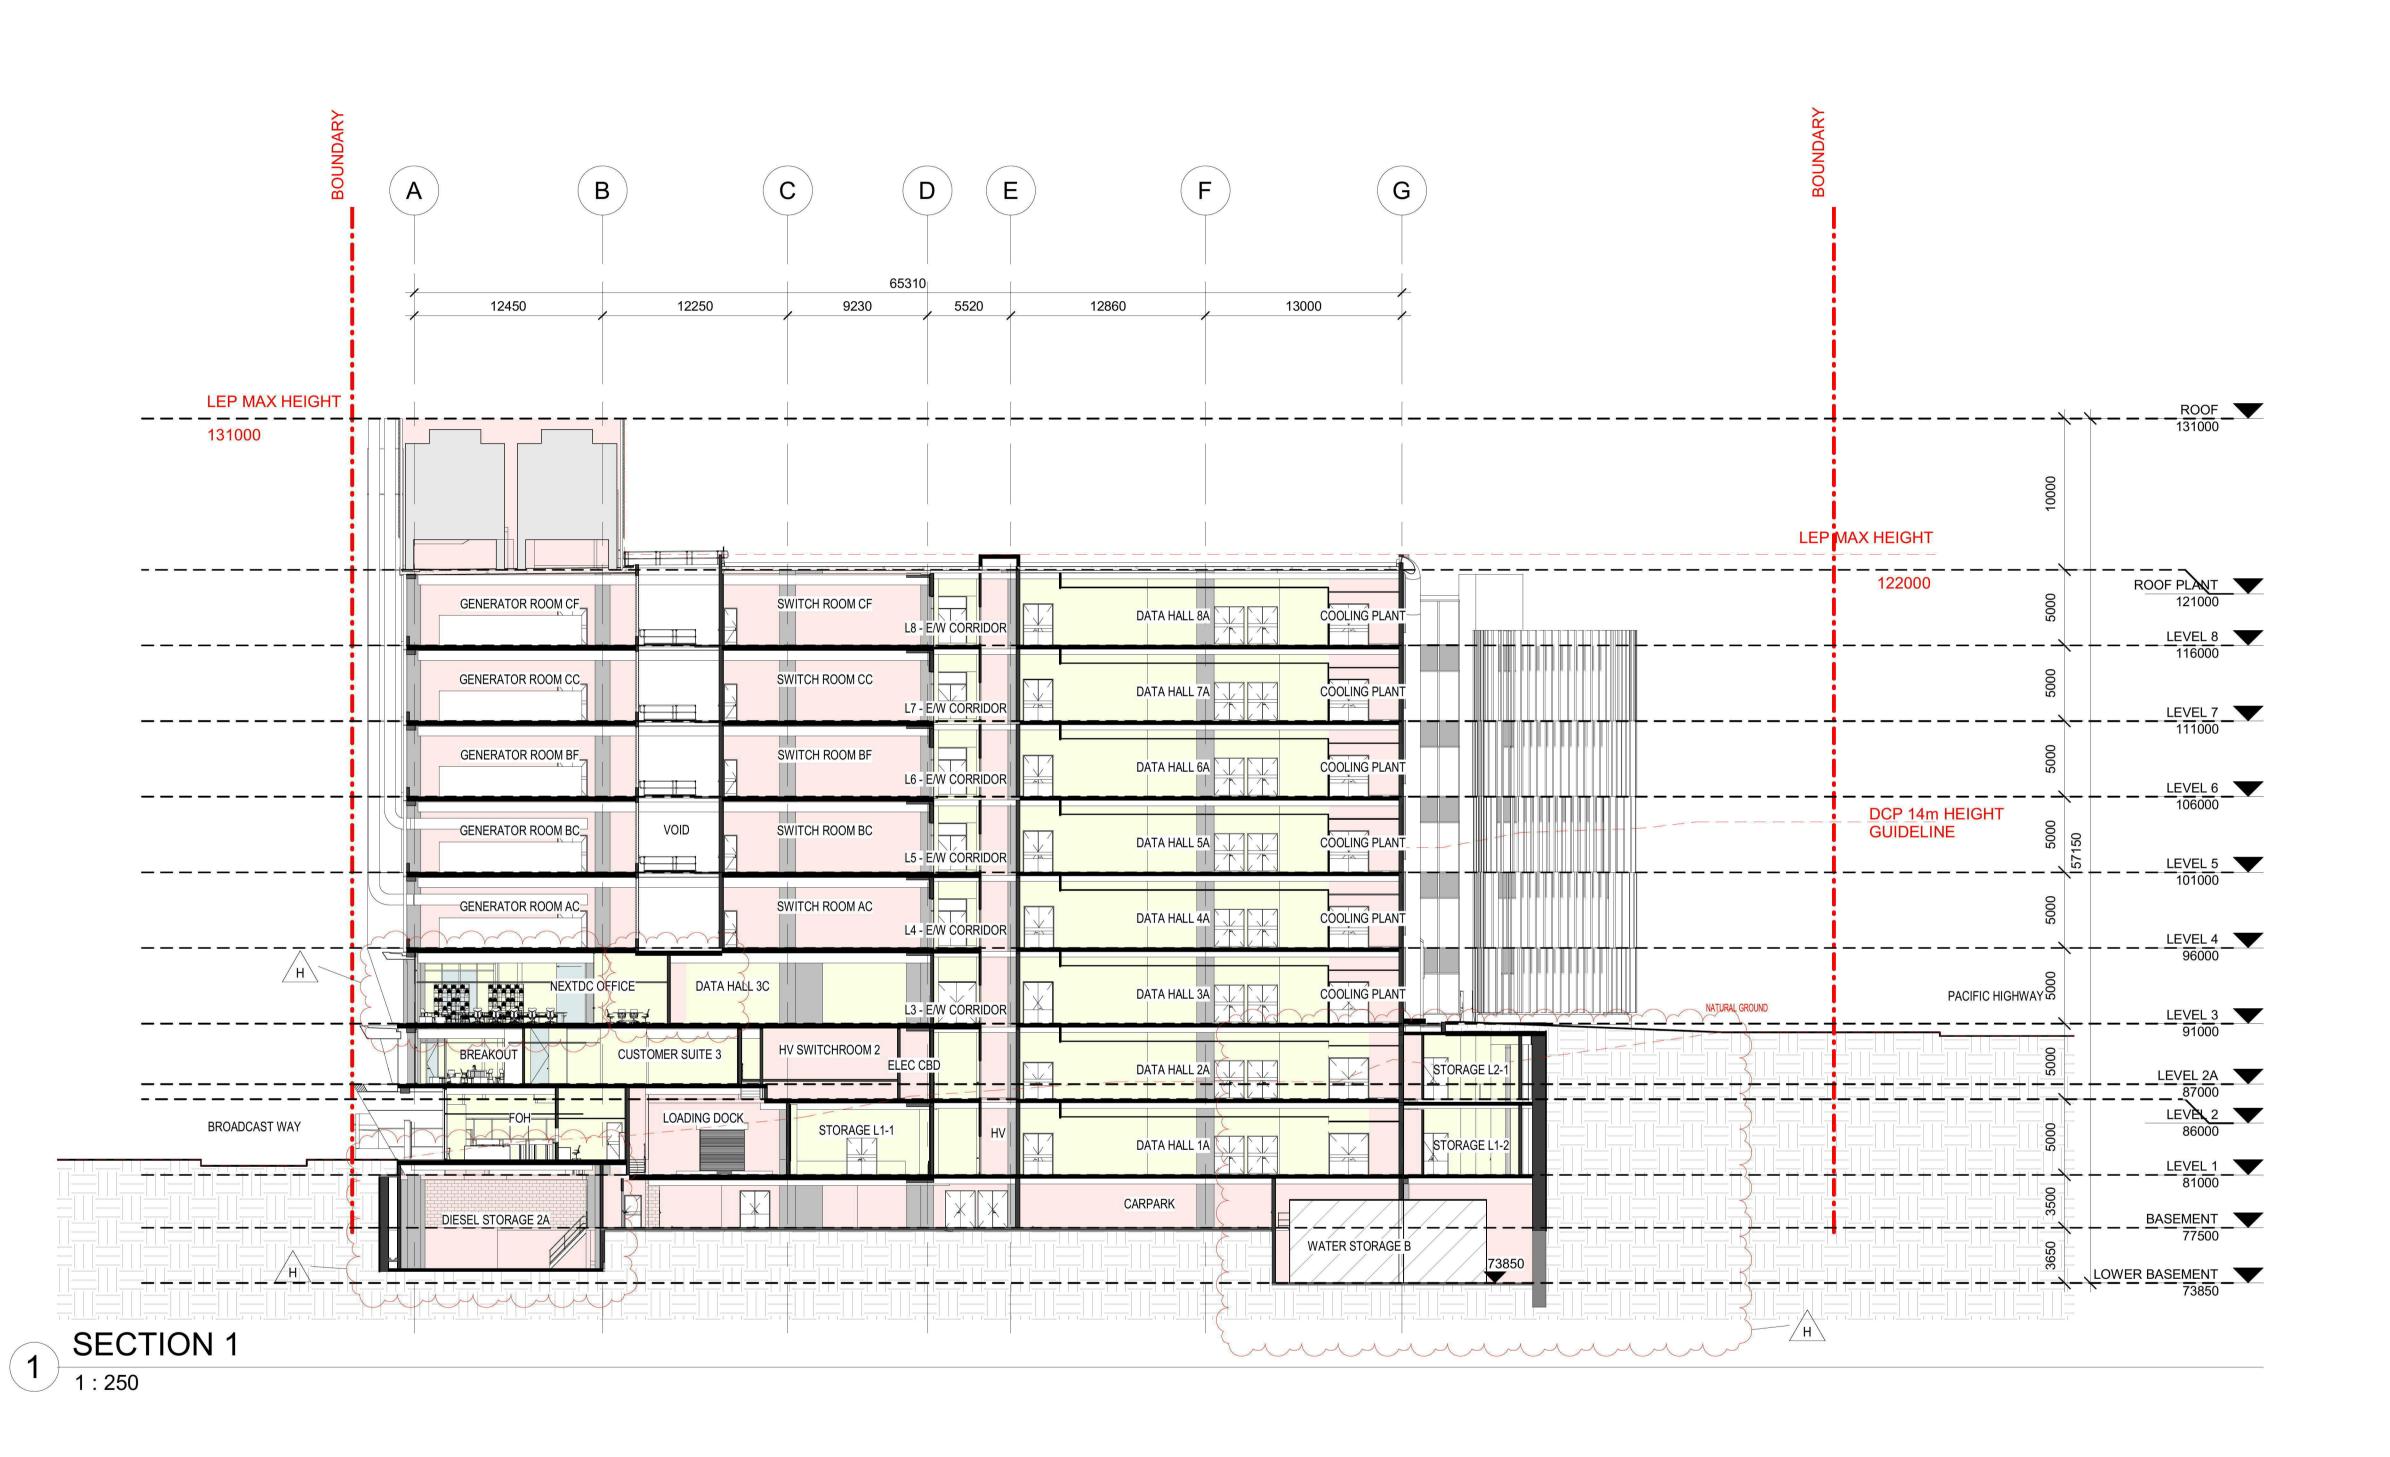

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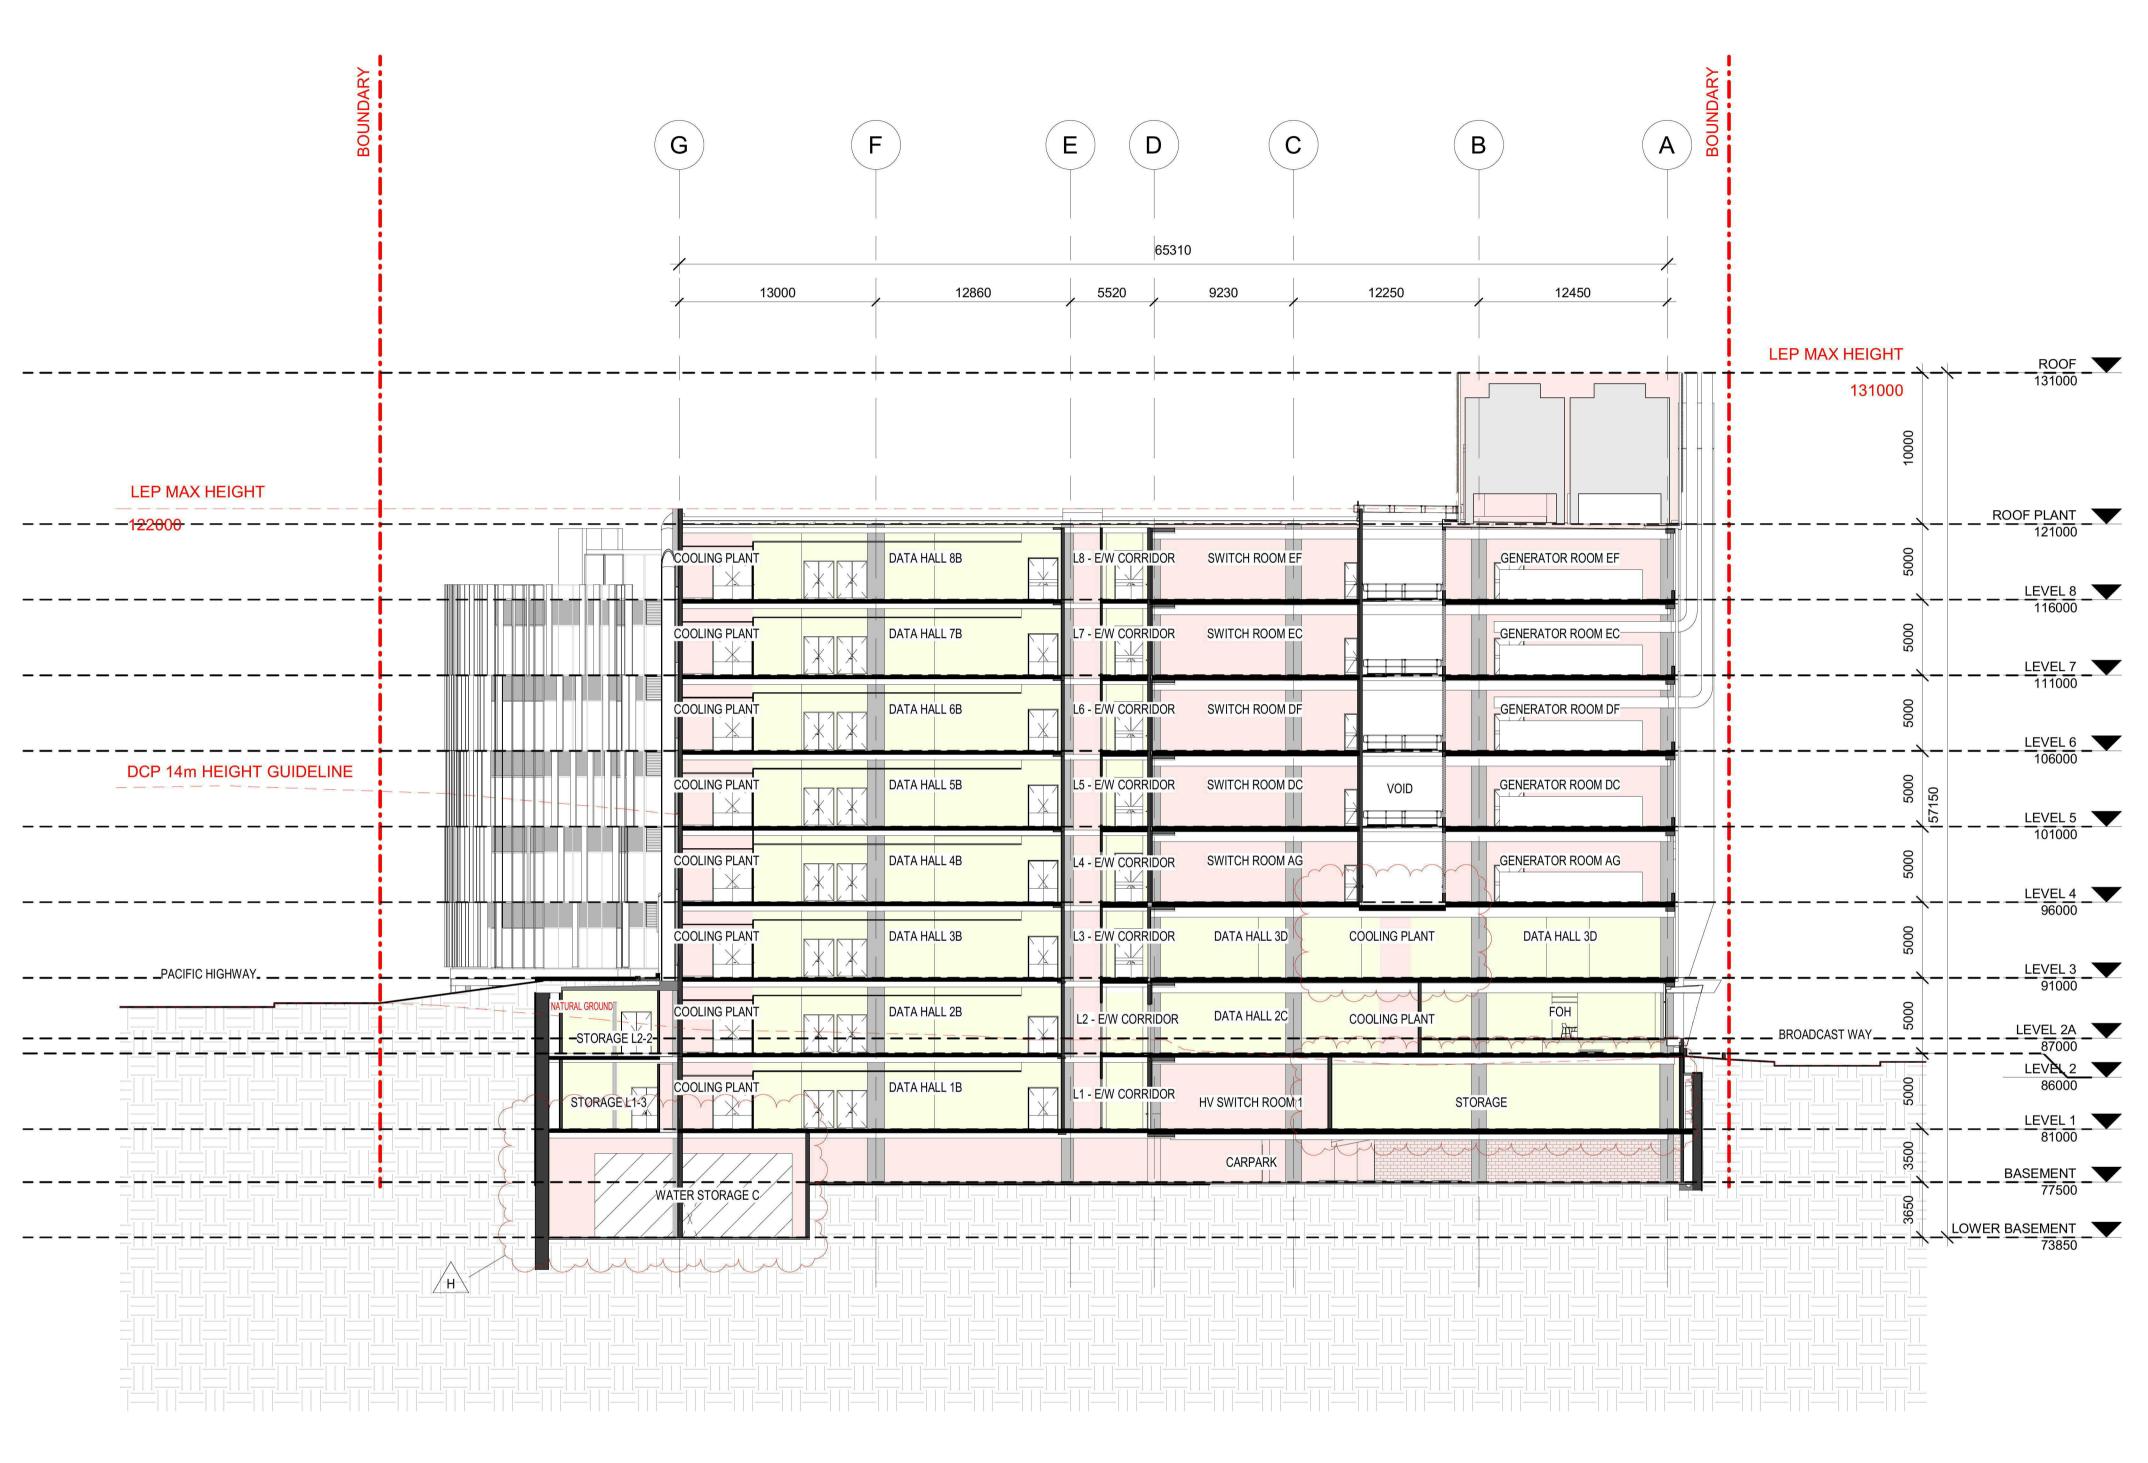
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S.4.55 Drawing Title **SECTION 1** 

S3- FAC- AR- DRG- DA250 [H]



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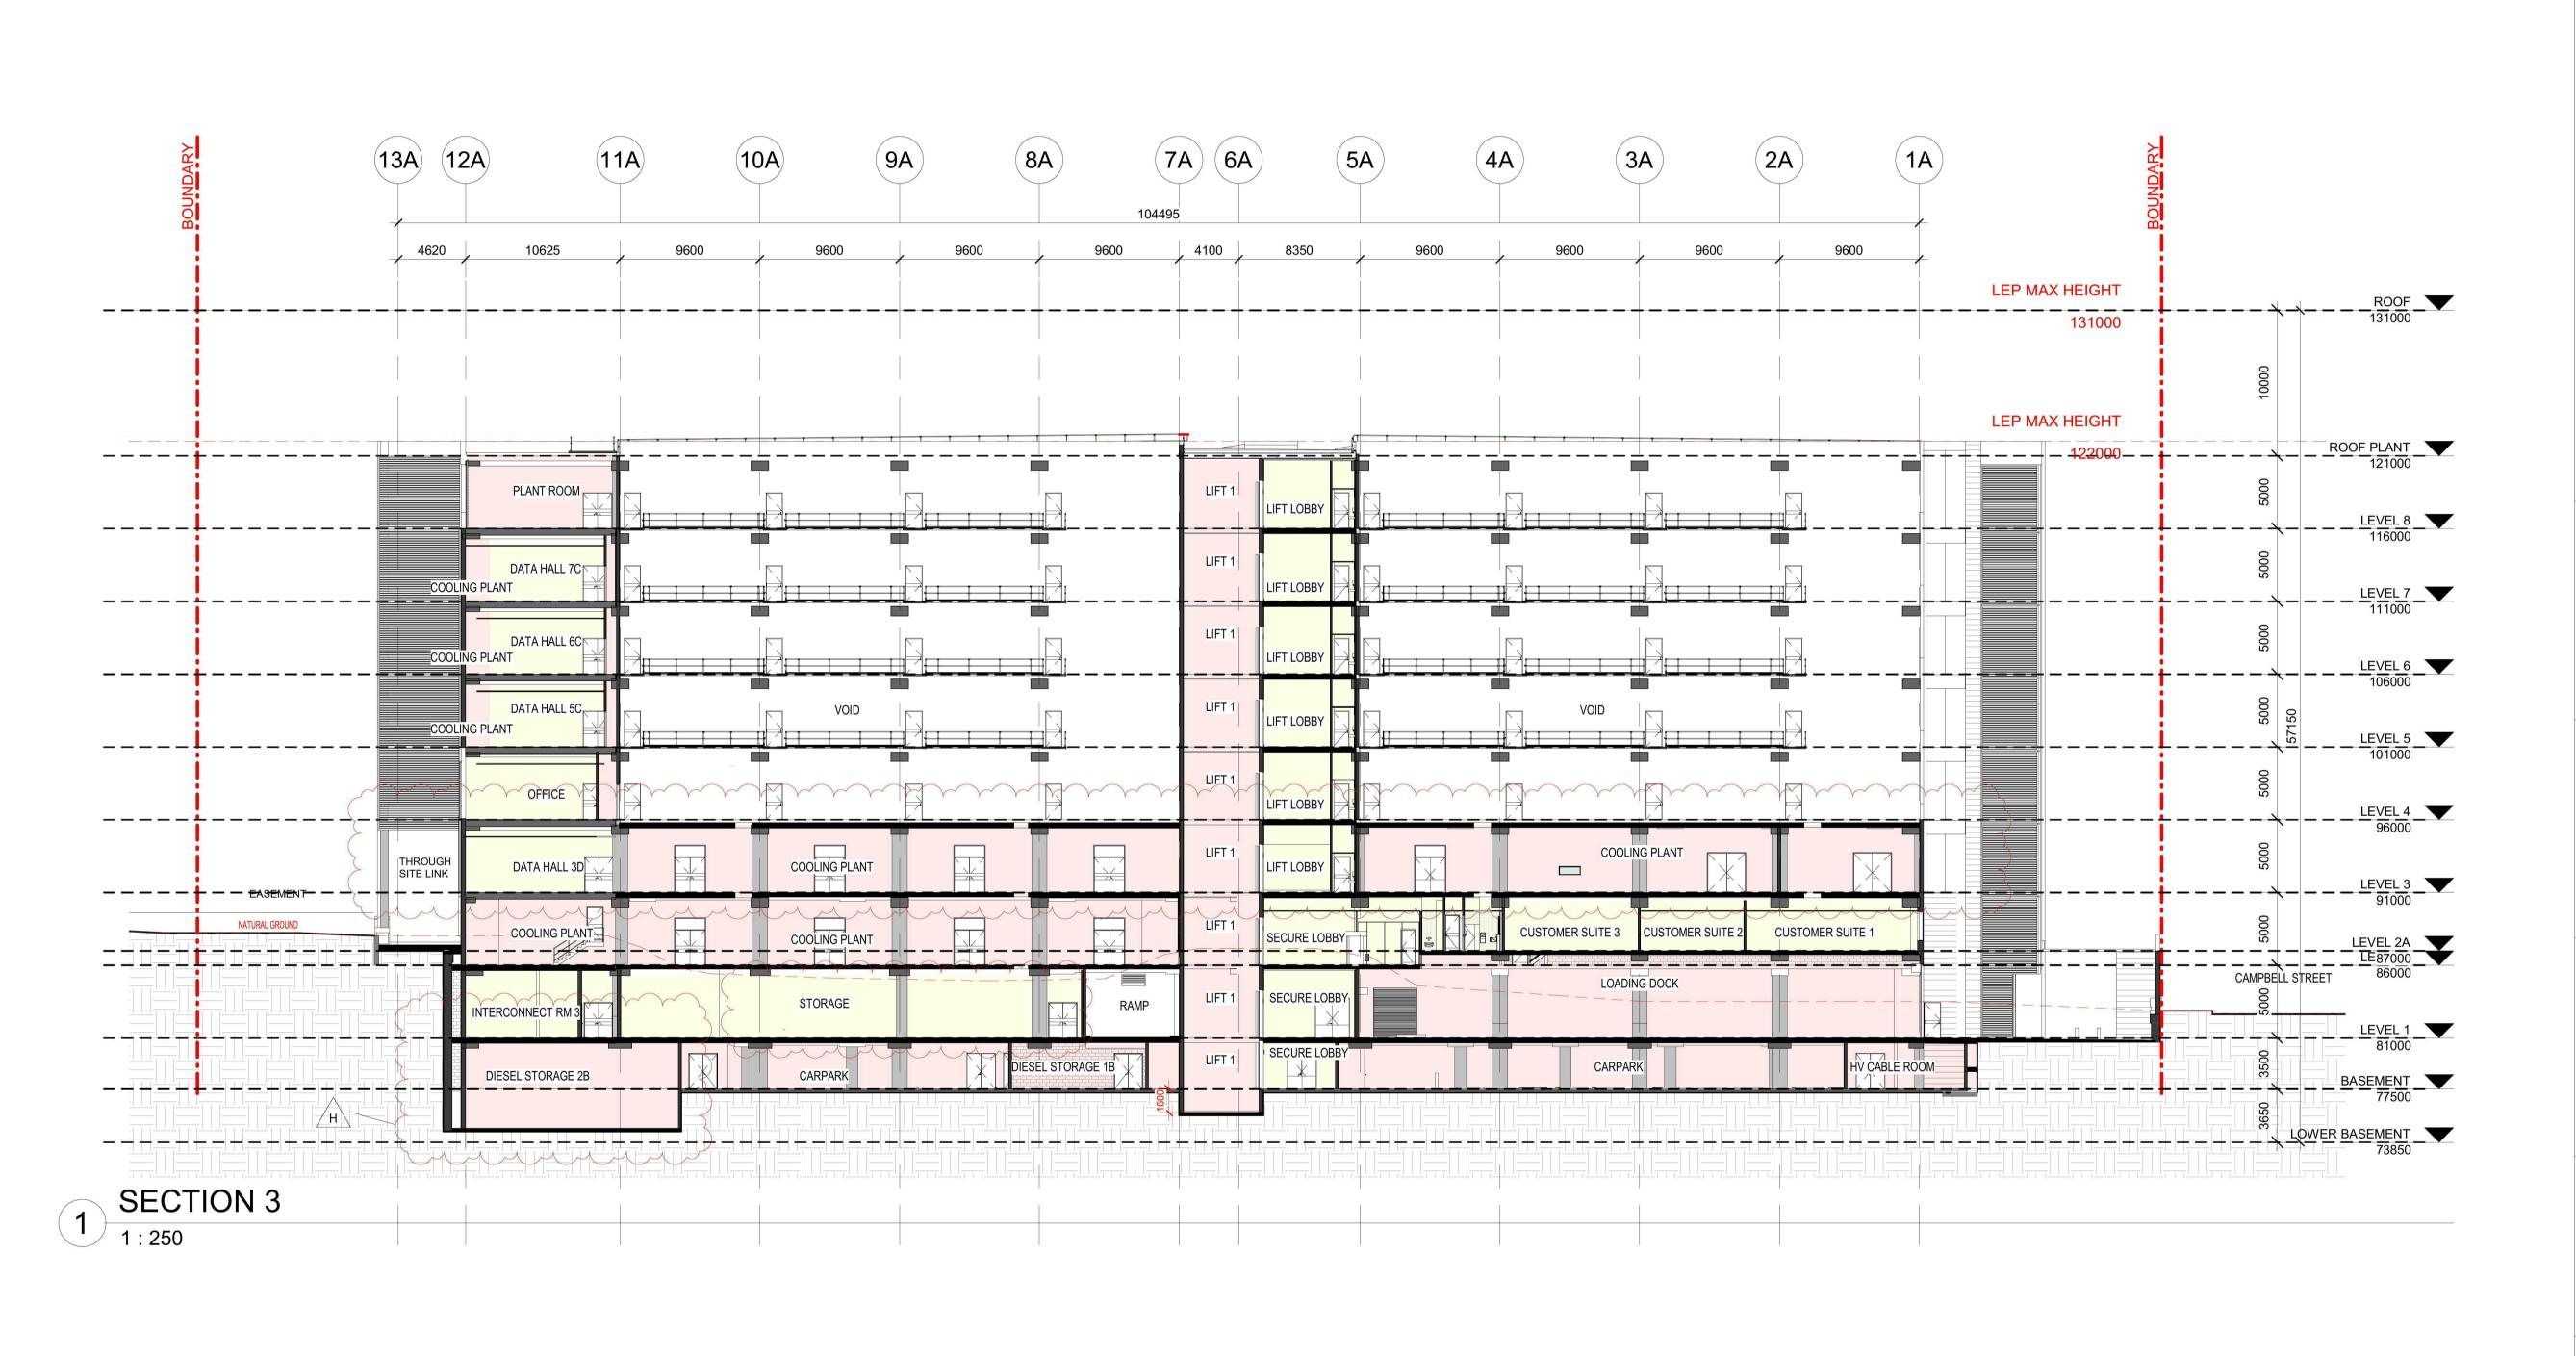
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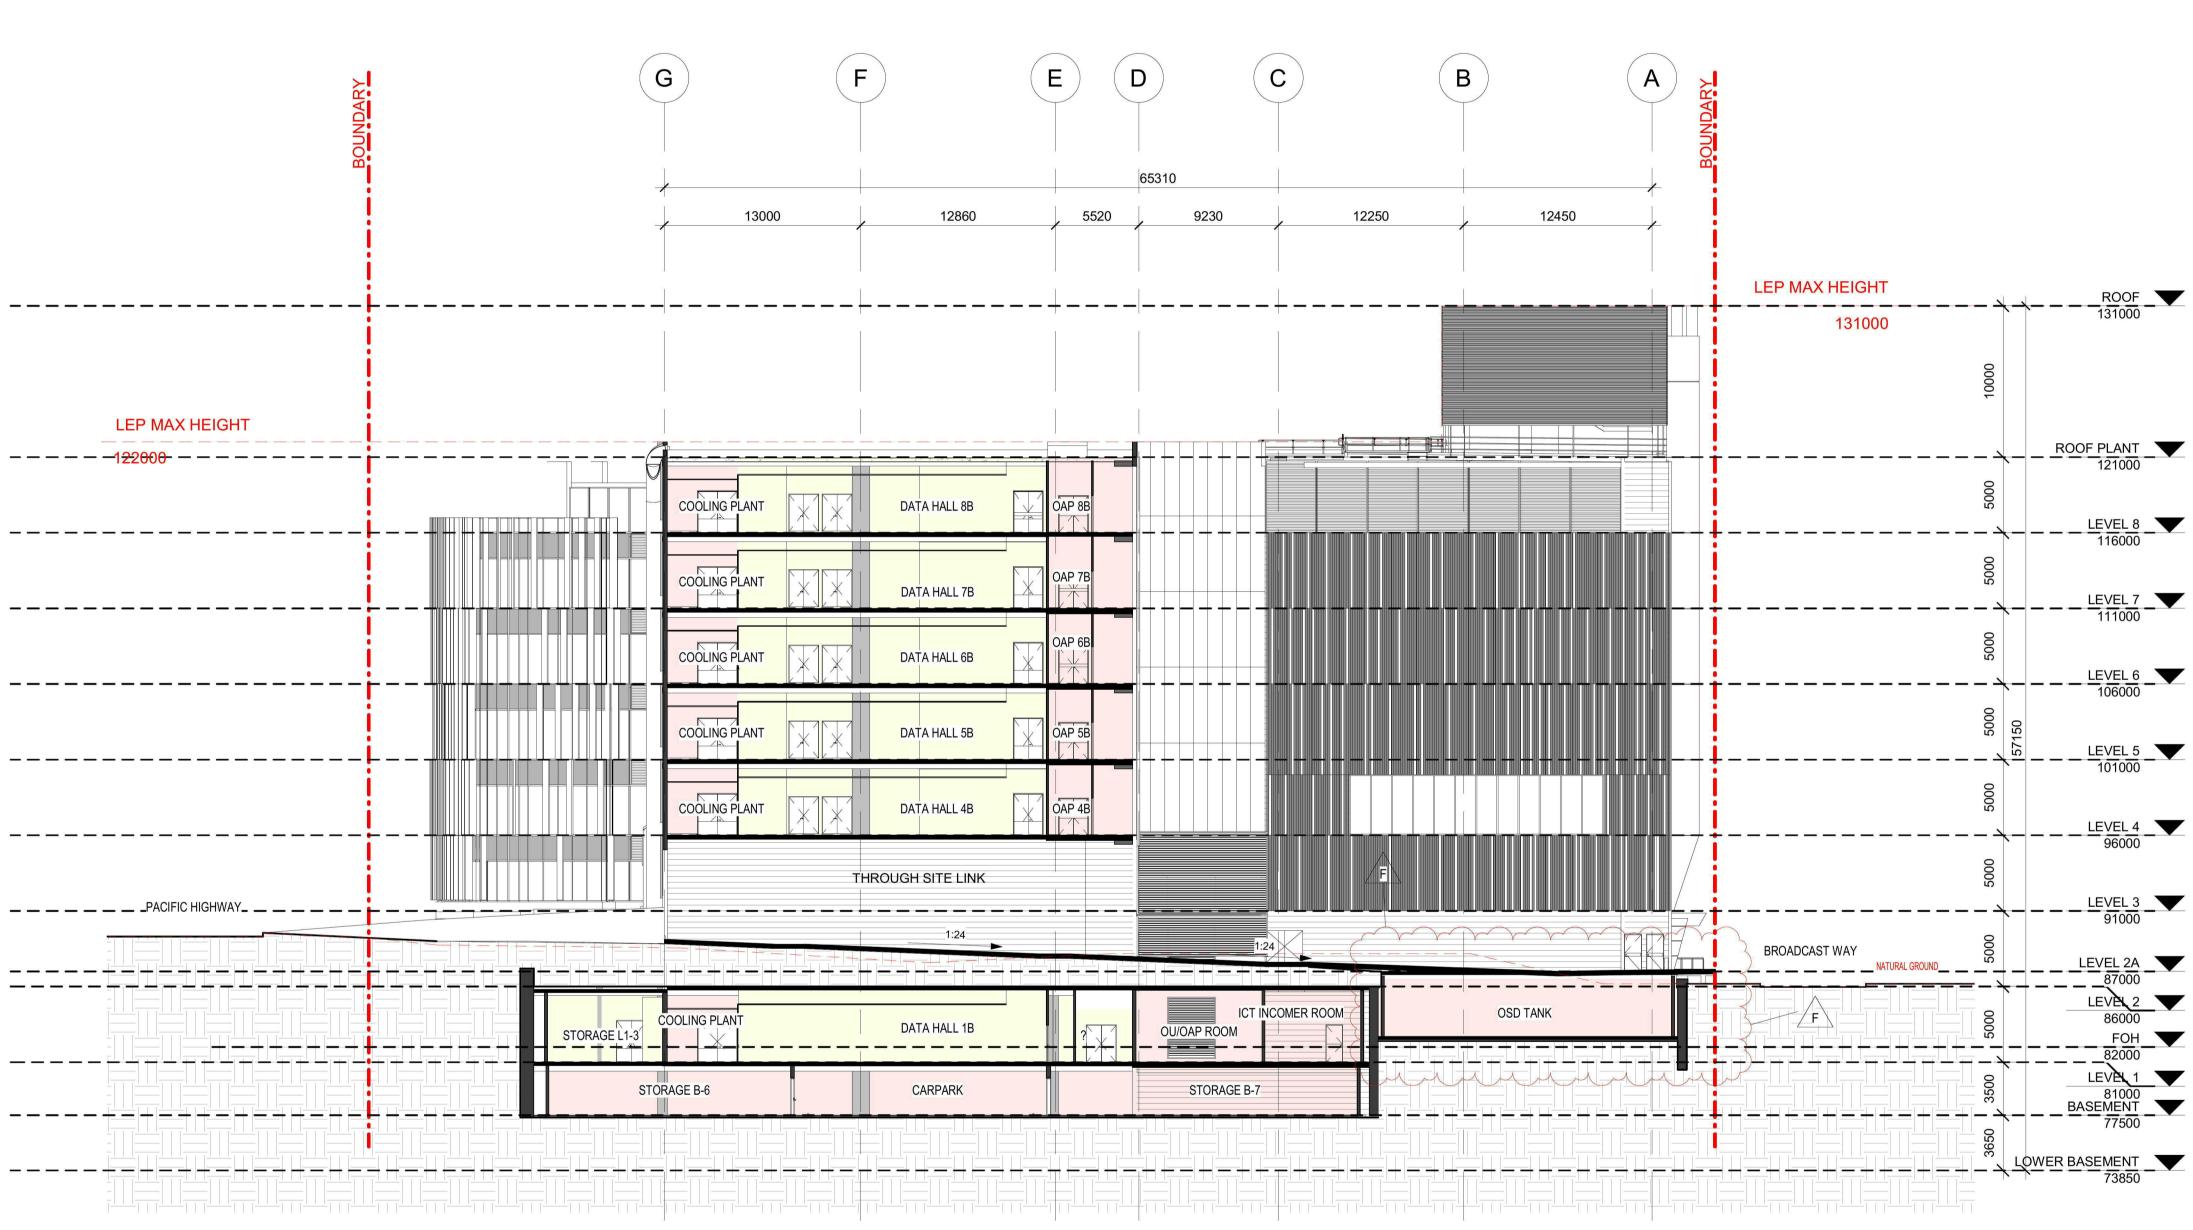
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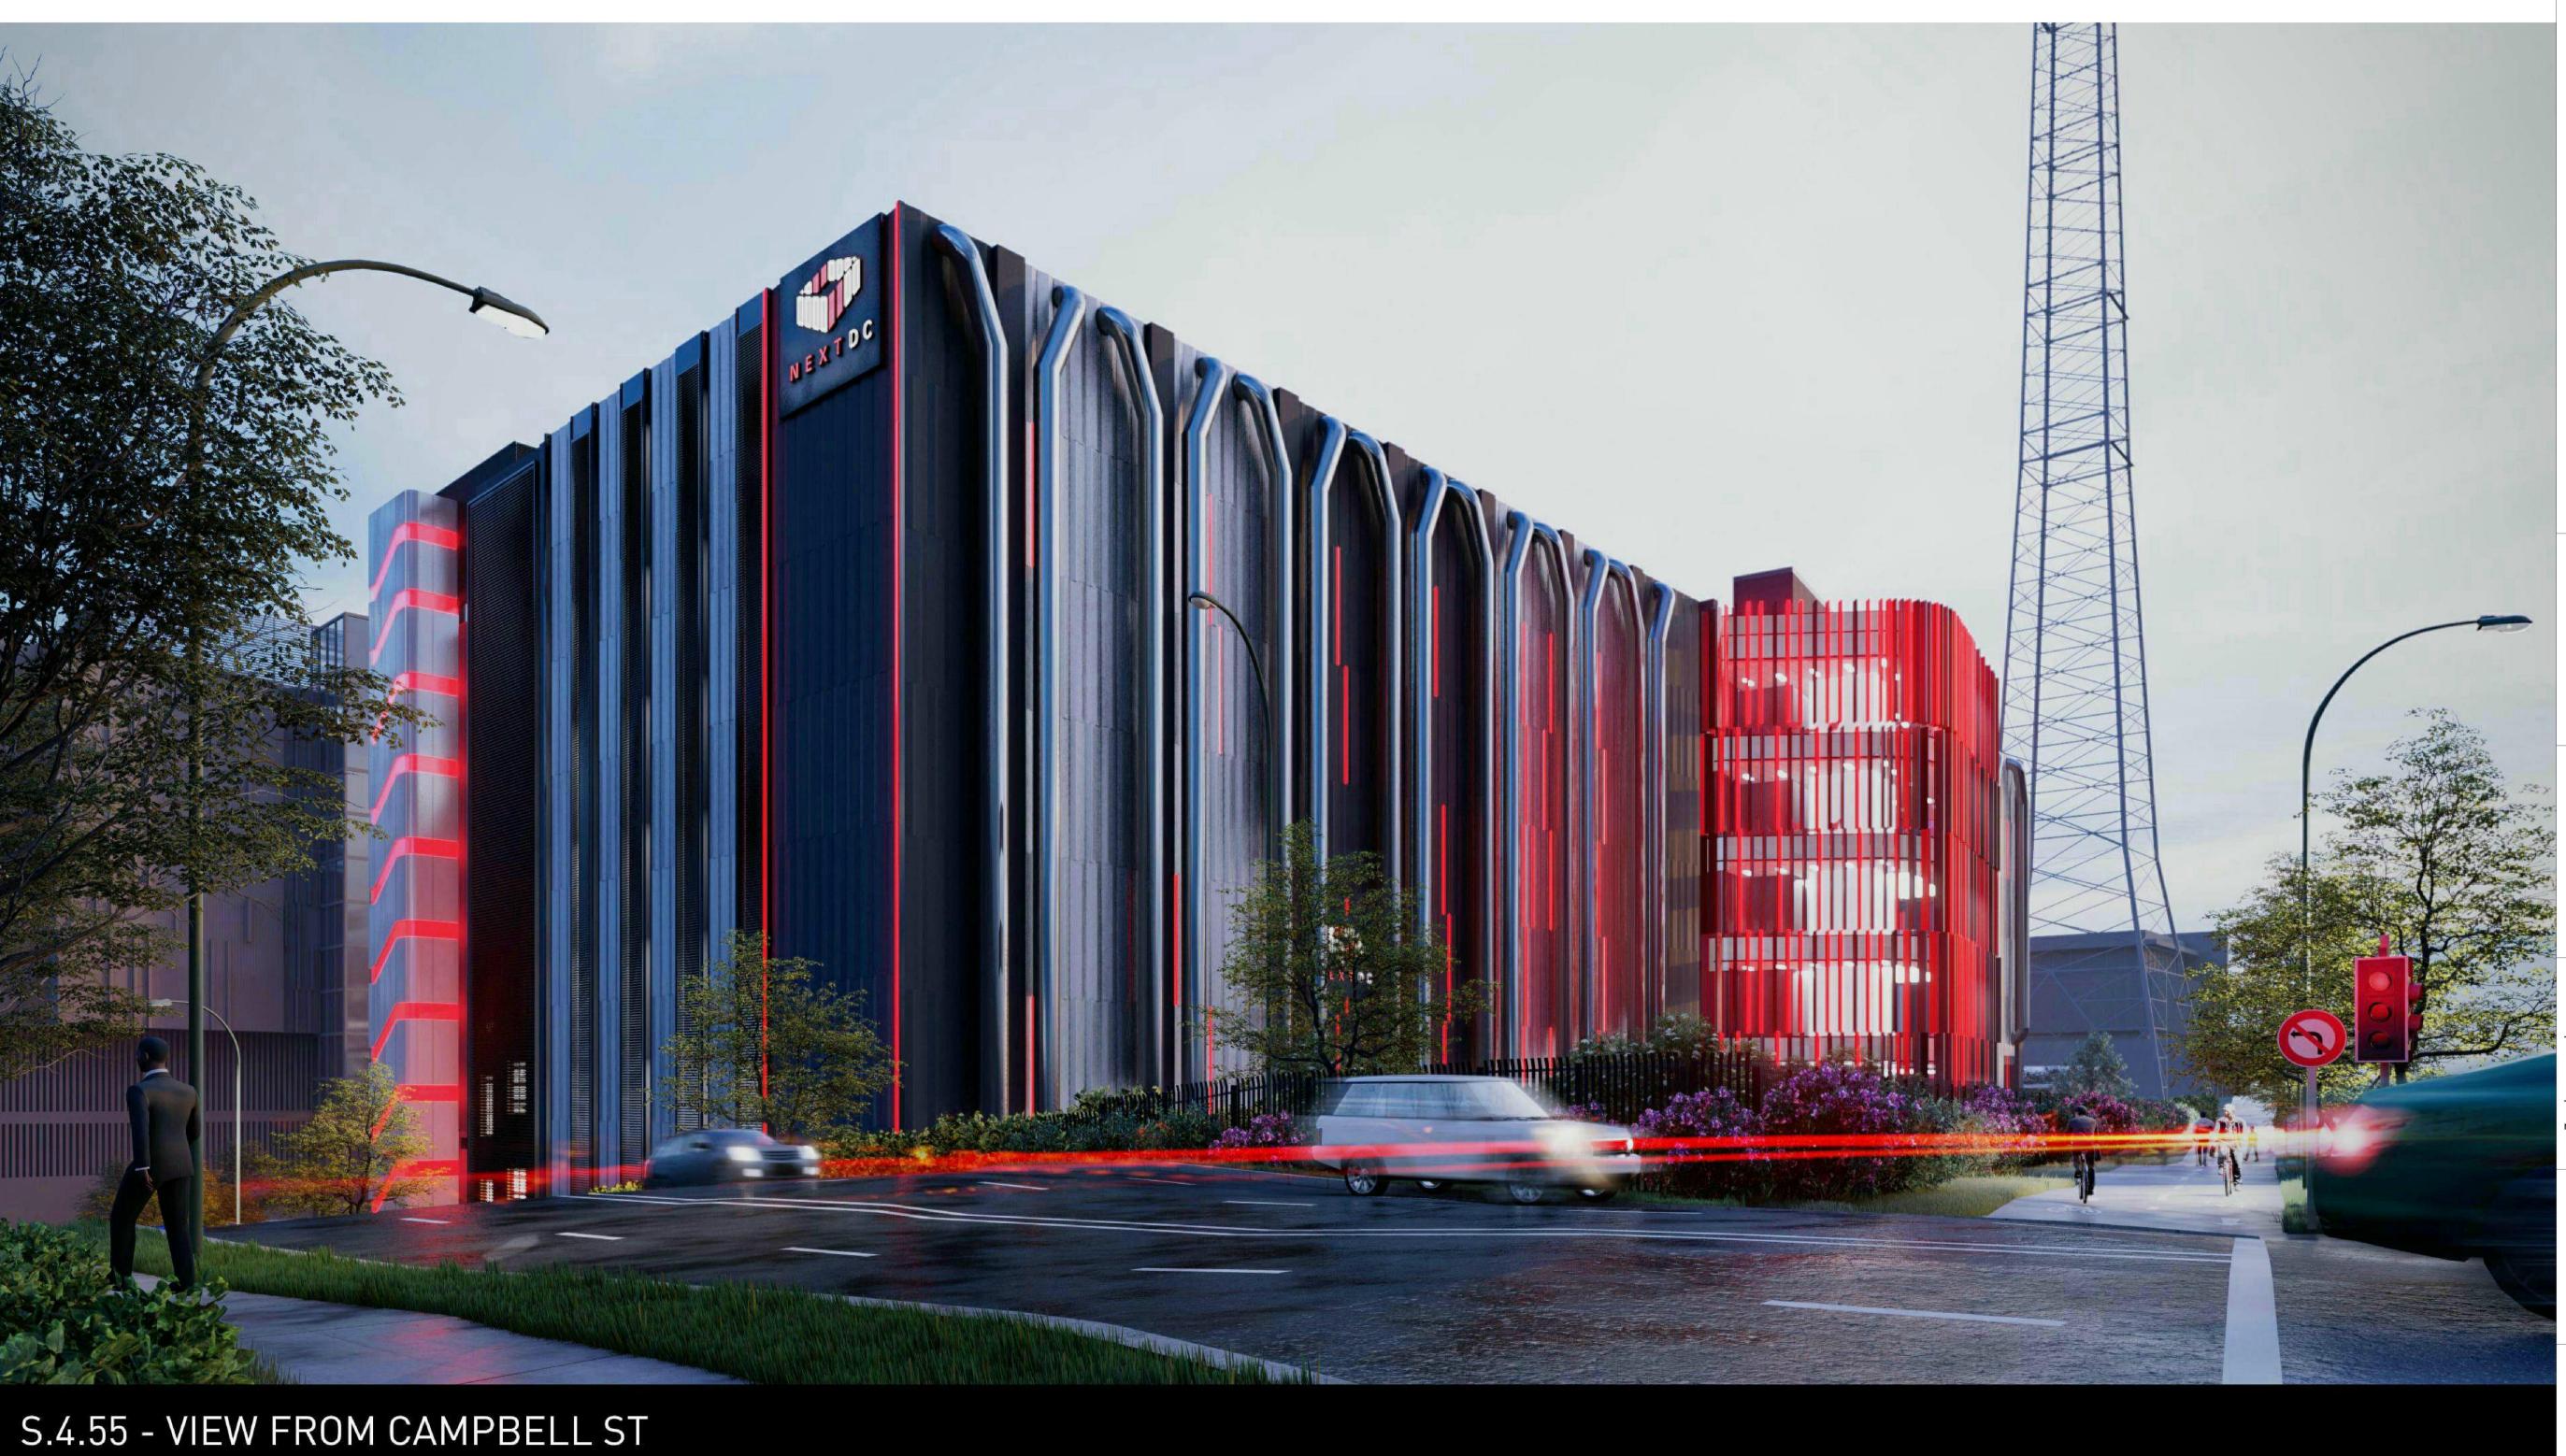
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SECTION 4

S3- FAC- AR- DRG- DA254 [F]



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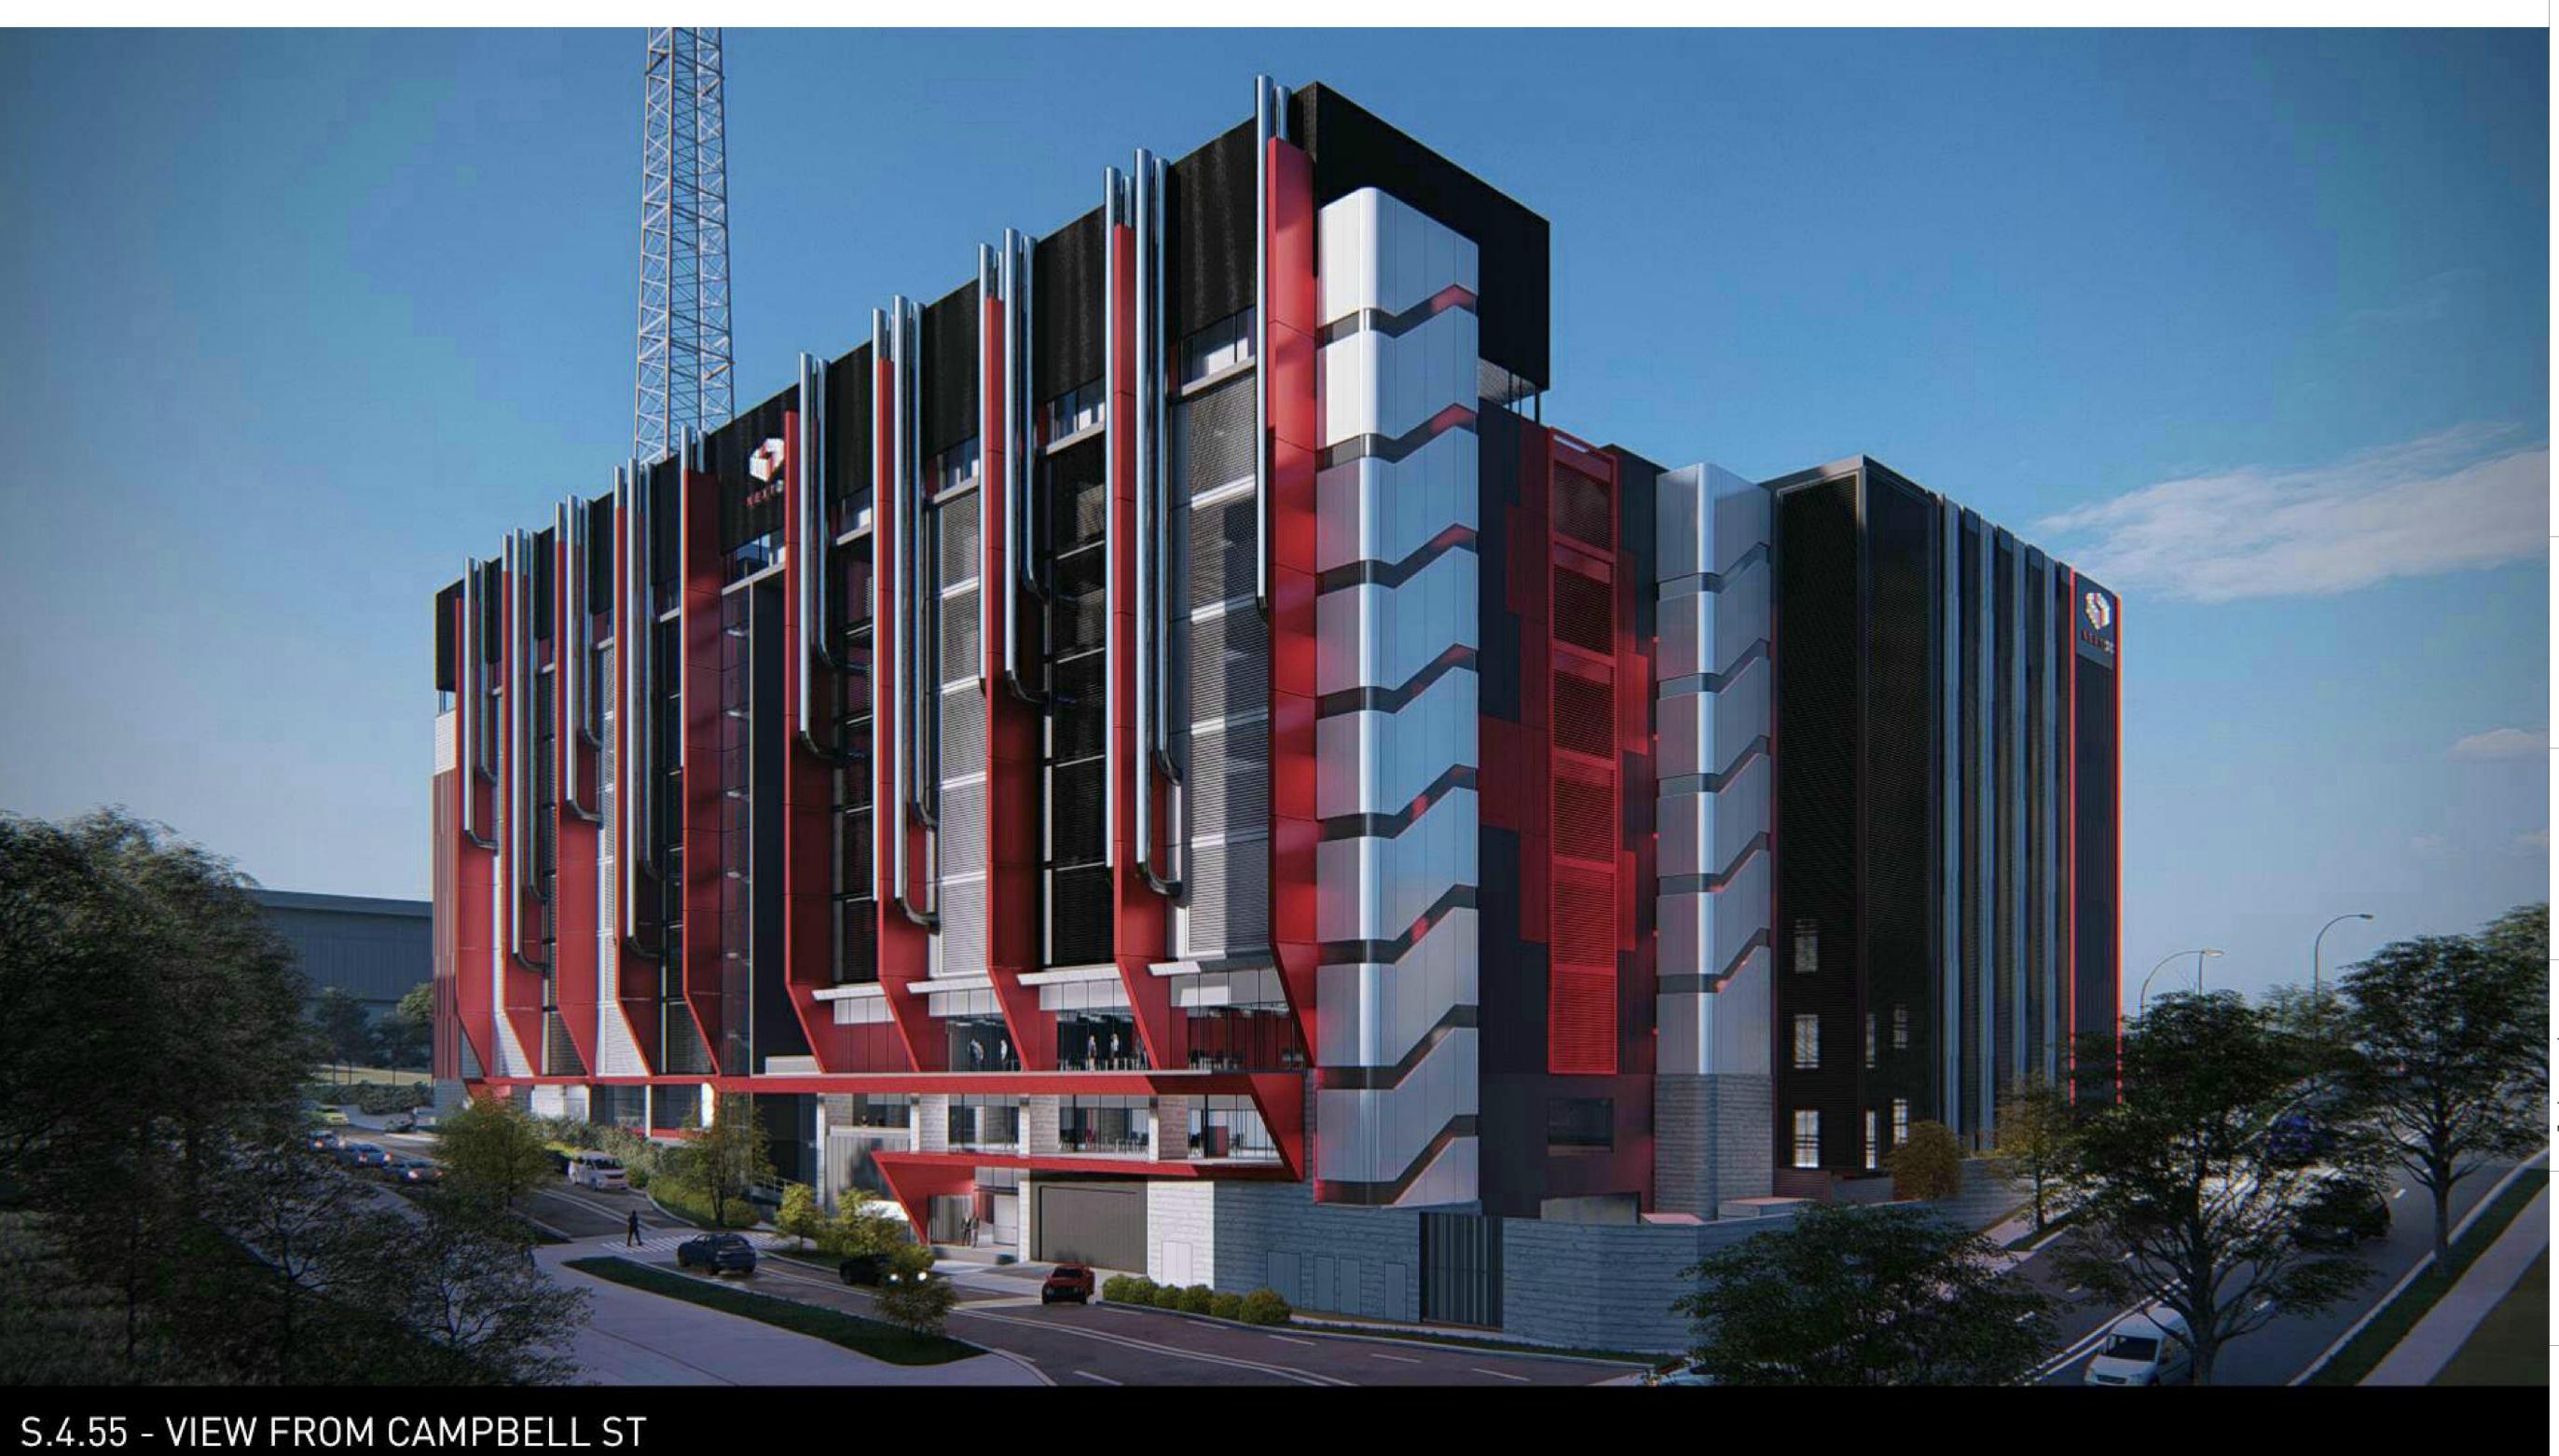
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Drawing Title
PHOTOMONTAGE 01

S3- FAC- AR- DRG- DA601 [D]



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Drawing Title PHOTOMONTAGE 02

S3- FAC- AR- DRG- DA602 [D]



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PHOTOMONTAGE 03

S3- FAC- AR- DRG- DA603 [C]



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Drawing Title
PHOTOMONTAGE 04

S3- FAC- AR- DRG- DA604 [D]



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### **INTRODUCTION**

This landscape design report has been prepared by Urbis for the proposed NEXTDC S3 data centre development located at 219-247 Pacific Highway, Artarmon. The landscape design presented incorporates the private landscape and through link along with Campbell Street and Pacific Highway streetscape upgrades. The landscape proposal has been prepared in compliance with Willoughby City Council DCP and DA application checklist.

### **SITE CONTEXT**

The site is located on a vacant block of land along the Pacific Highway and is located within the industrial area of Artarmon. The site is approximately 7km from the Sydney CBD. The adjoining properities consist of light industrial buildings, television broadcast tower and Fox Sport headquarters to the south-east. The remainder of the site is bound by the Pacific Highway to the south-west, Campbell Street to the north and Broadcast Way to the north-east.

### **DEVELOPMENT PROPOSAL**

The design responds to the following key areas:

- Setback landscaping that will be low maintenance, shade and drought tolerant
- Streetscape landscaping that aligns with Councils design guidelines



Image: Near Maps Image









### **DESIGN RESPONSE**

### **METHODOLOGY**

The landscape design strategy for the NEXTDC S3 Data Centre comprises of the private setbacks and the streetscape landscapes. The landscape will align with the Willoughby City Council Control Plan Policies. Private landscapes will be a mixture of shrubs, groundcovers and turf planting, these will be layered to provide privacy to the street and be of low maintenance. Proposed trees in the site are situated appropriately in the lot setback, and have been prescribed from a council specified

The proposed streetscape will concisely follow the councils guidelines. Pacific Highway streetscape upgrade:

- In-situ concrete paving
- Turf verge
- New street trees
- Relocated street lights to align with new street trees
- Relocated bustop closer to the corner of Campbell Street and Pacific Highway

Campbell Street streetscape upgrade:

- In-situ concrete paving and markings to 3m shared path
- Turf verge

These upgrades will reflect the existing street characters associated with mixed use, commercial and business as outlined within the public domain technical

### PLANT ESTABLISHMENT + MAINTENANCE

Landscape Maintenance Strategy

#### General

Planting maintenance period: the planting maintenance period will be 52 weeks and will commence from the date of practical completion. Of each phase of planting works (hereby specified to be a separable part of the works). It is anticipated that planting works will be undertaken in one phase

Planting maintenance program: 2 weeks prior to practical completion, furnish a proposed planting establishment program, and amend it as required. Such proposal should contain details of the types and frequency of maintenance activities involved with the establishment of plants and grassed areas. Comply with the approved program.

Planting maintenance log book: keep a log book recording when and what maintenance work has been done and what materials, including approved toxic materials, have been used. Log book must be signed off by the client's representative after each maintenance visit. Maintain log book in location nominated by superintendent. All entries are to be initialled by person nominated by superintendent. Log book to contain a copy of the approved planting establishment program.

Product warranty: submit the supplier's written statement certifying that plants are true to the required species and type, and are free from diseases, pests and weeds.

Insurance: the contractor is to ensure suitable insurance cover and / or bank guarantee is in place for the theft and / or damage of all works executed under this contract for the plant maintenance period.

#### Planting Maintenance

Protection of works: provide any fencing or barriers necessary to protect the planting from damage throughout the planting establishment period.

Recurrent works: throughout the planting maintenance period, continue to carry out recurrent works of a maintenance nature all to the extent required to ensure that the plants are in the best possible condition at the end of the planting maintenance period. These activities are including but not limited to:

Weeding,

Rubbish removal,

Fertilizing,

Pest and disease control,

Adjust / replace stakes and ties

Topping up mulch,

Cultivating,

Pruning,

Keeping the site neat and tidy

Replacements: the contractor is responsible for the replacement of failed, damaged or stolen trees, shrubs and groundcovers throughout the planting establishment period.

#### Weeding

Generally: regularly remove, by hand, rubbish and weed growth that may occur or recur throughout turfed, planted and mulched areas. Continue eradication throughout the course of the works and during the planting establishment periods.

Weed eradication: the contractor must make allowance for a higher level of maintenance during establishment to ensure that weeds are controlled.

Herbicide use: re-application of herbicide such as Ronstar or equivalent if required.

Requirement: plant maintenance shall be deemed complete subject to the following compliance with the criteria:

Repairs to planting media completed

Ground surfaces are covered with the specified treatment to the specified depths

Pests, disease, or nutrient deficiencies or toxicities are not evident.

Organic and rock mulched surfaces have been maintained in a weed free and tidy condition and to the specified depth

Vegetation is established and well formed

Plants have healthy root systems that have penetrated into the surrounding, undisturbed ground and not able to be lifted out of its planting hole

Vegetation is not restricting essential sight lines and signage

Collection and removal of litter

All non-conformance reports and defects notifications have been closed out.

Plant maintenance compliance schedule:\*as defined by the superintendent

#### Pruning

Generally: tree plantings shall be left to grow in a form consistent with the growth habit of the species.

Pruning: cut back tree canopies and groundcovers to road verges, and light poles and signs as required achieving clear sight lines when viewed along roadway. Requirement: pruning to be undertaken by a qualified tree surgeon / arborist

#### Fertilising

Generally: the fertiliser regimes have been devised to provide sufficient long-term fertility for the vegetation type and it is anticipated that all except the very high status horticultural beds such as feature plantings (entry and courtyard planting) for colour and foliage will not need regular fertiliser regimes.

Testing: additional nitrogen may be required due to drawdown effects from composts and mulches and localised waterlogging. To compensate for this, soil testing is to be carried out after 12 months to ascertain nutrient requirements.

#### Completion

Cleaning: remove temporary protective fences and tree stakes at the end of the planting maintenance period.

Drainage & Watering Strategy

#### Generally:

If the watering regime is intended to be amended the contractor must seek written approval from the superintendent immediately prior to the deferment of

Watering permits: the contractor is responsible for obtaining the necessary watering permits required to carry out the watering as specified.

All irrigation systems will comprise of subsurface drip systems and automatic timers with rainwater / soil moisture sensor controls:

Where possible storm water runoff will be directed to the lawn and garden beds;

Irrigation will be provided to all soft landscape areas and will be specified within the tender package; Low water demand shrub planting is proposed.

### **LIGHTING**

All external areas will be designed to meet relevant Australian Lighting Standards. Integrated landscape lighting is proposed to all the landscape elements. Final lighting layout to be confirmed by electrical engineer

### **SAFETY AND SECURITY**

An integrated approach to safety will improve actual and perceived personal security in pedestrian public domain

All paths are overlooked from adjoining buildings and adjacent streets which will provide a high level of passive surveillance;

All external spaces will have multiple clear sight lines without obstacles, proposed shrub planting is low level which will prevent places to hide;

All paths will be well lit at night time and designed to meet relevant Australian Lighting Standards;

Signage will be provided across the precinct to assist with wayfinding and navigation through the site.

### **WATER MANAGEMENT + WSUD**

Water Sensitive Urban Design (WSUD) principles have been realised into the landscape design in a way that celebrates a sustainable water cycle.

Stormwater will be designed in accordance with NextDC S3's Stormwater Management Guidelines (refer to engineers details)

Irrigation will be provided to all soft landscape areas and will be specified within the tender package.

Any On-site detention requirements have been outlined within the engineers stormwater management report. Refer to engineers drawings for details concerning stormwater and drainage.

### **EXISTING TREE STRATEGY**



#### **EXISTING TREE STRATEGY**

- The project site is devoid of any significant trees or vegetation. Remaining trees and vegetation inside property boundary are to be removed.
- Broadcast Way street trees are to be retained following DCP guidelines.

#### LEGEND




Existing Street Trees to be Retained



- Property Boundary / Extent of Works

## PUBLIC DOMAIN / LANDSCAPE MASTER PLAN

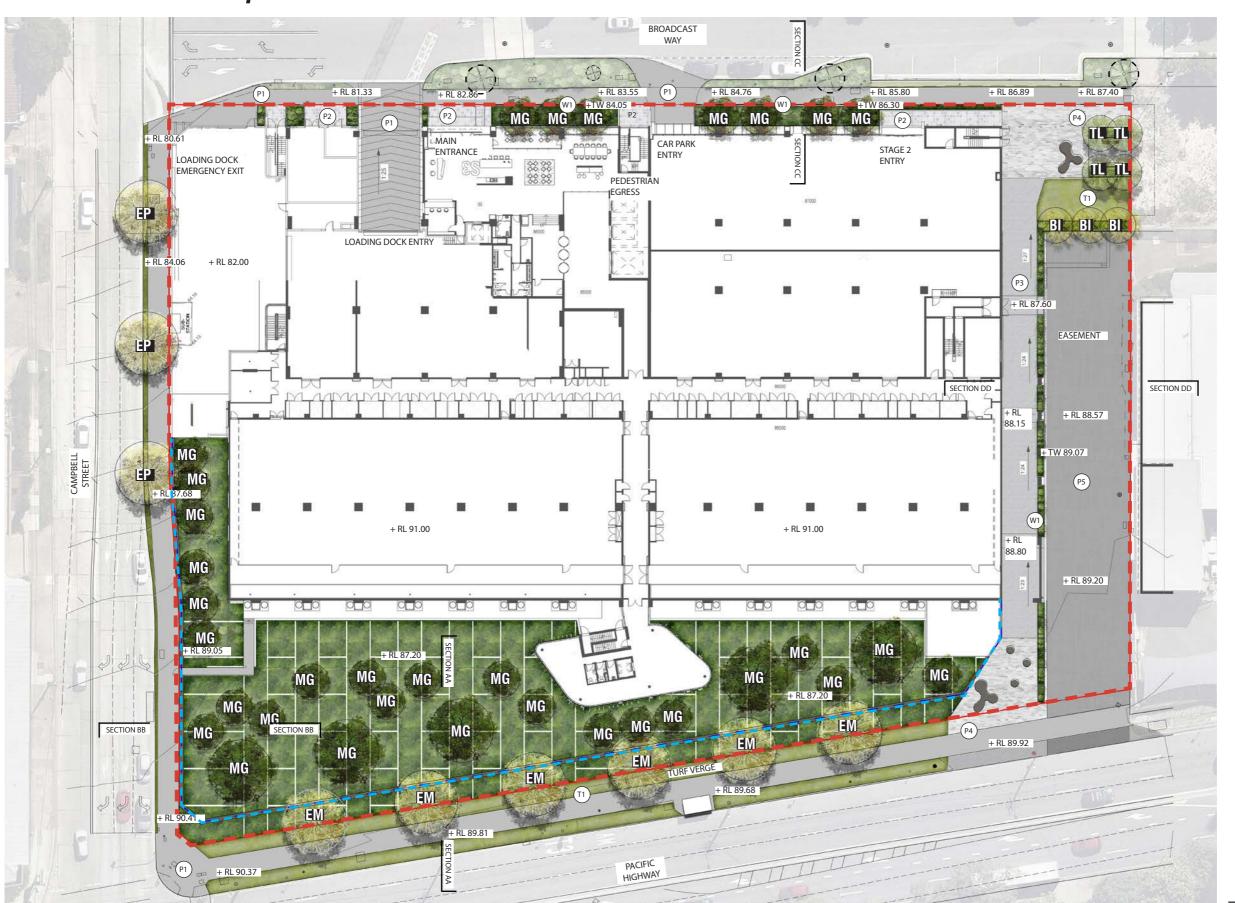

#### Legend

Property Boundary

Security Fence (refer architects drawings)

(P1) In-situ Concrete Path

(P2) Grey Unit Paving

Large Concrete Unit Paving

(P4) Small Concrete Unit Paving

P5 Bitumen

(W1) Insitu Concrete Wall

) Sir Walter Soft Leaf Buffalo Turf

Trees to be Retained

+ RL 0.00 Spot Levels

+TW 0.00 Top of Wall Levels


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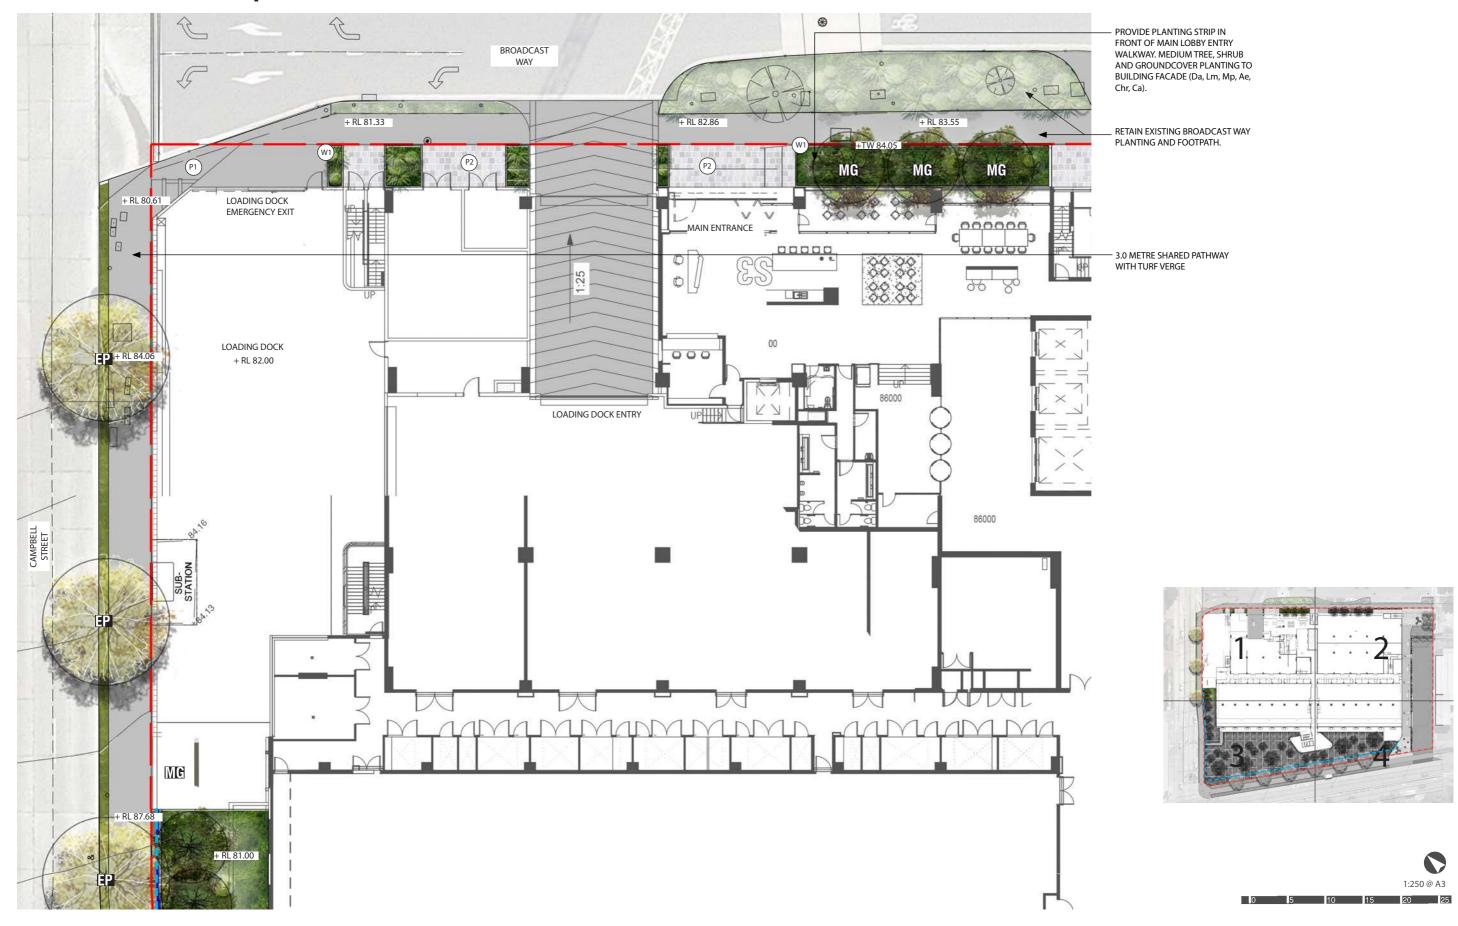
Note: Refer materials strategy page for paving




# PUBLIC DOMAIN / LANDSCAPE CIRCULATION MAP



# **PUBLIC DOMAIN / LANDSCAPE DETAIL PLAN 1**

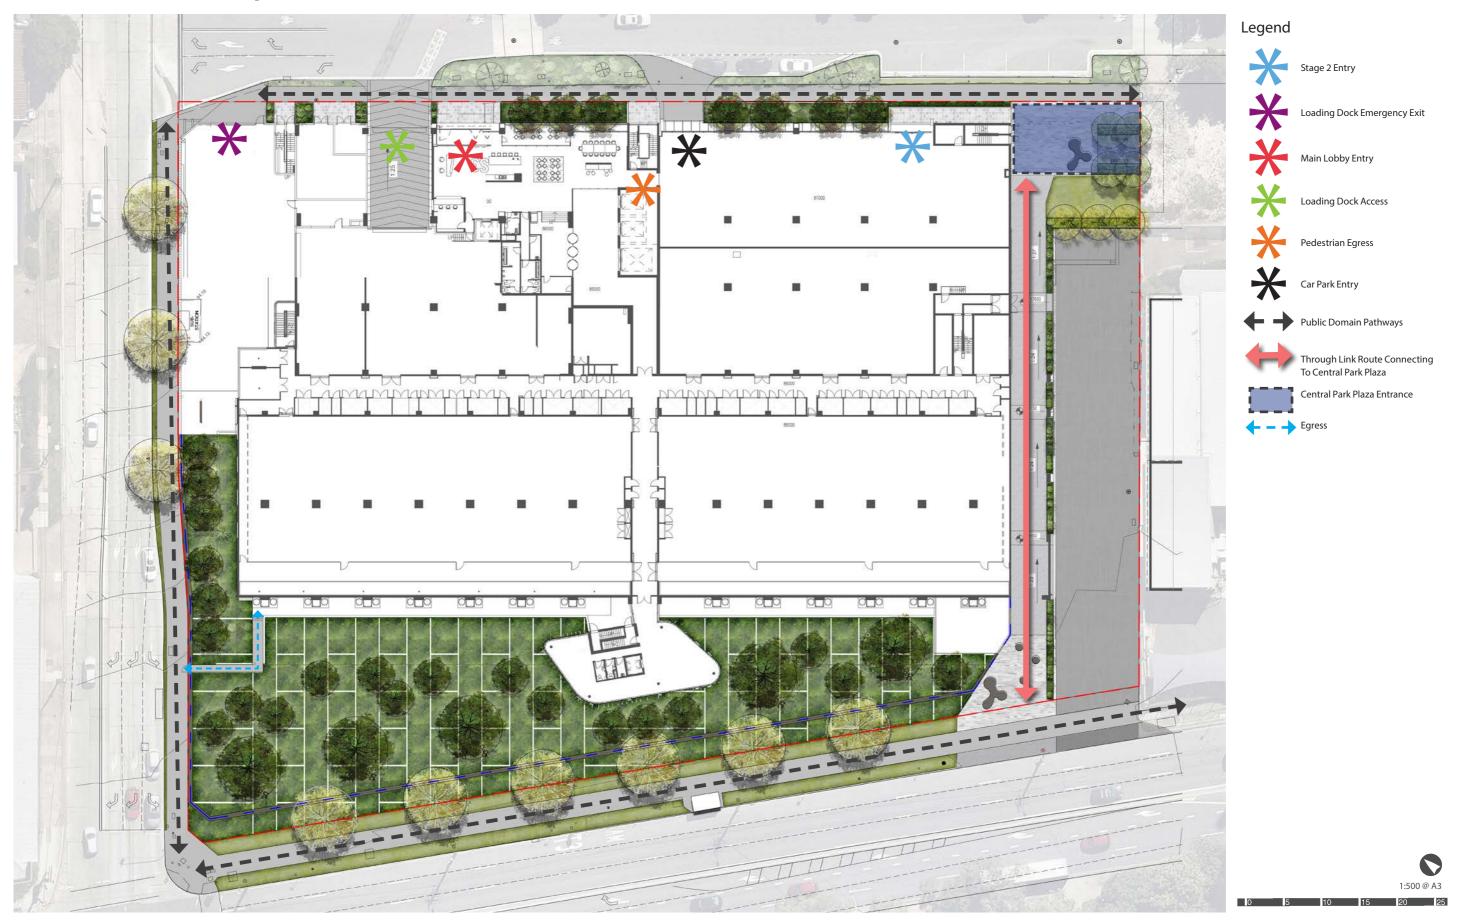


# PUBLIC DOMAIN / LANDSCAPE DETAIL PLAN 2

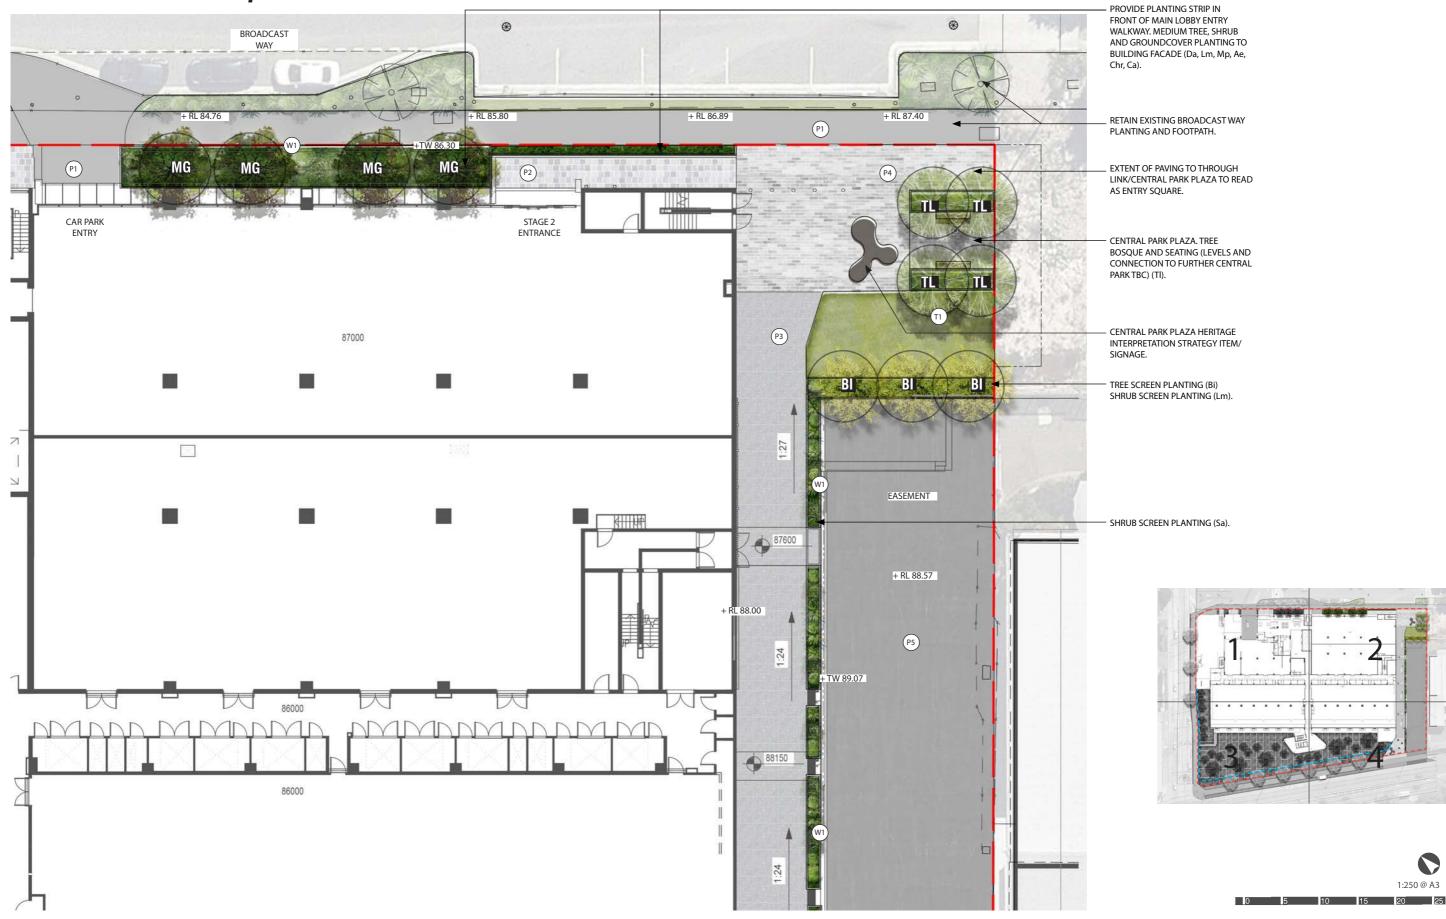


# PUBLIC DOMAIN / LANDSCAPE DETAIL PLAN 3



# PUBLIC DOMAIN / LANDSCAPE DETAIL PLAN 4

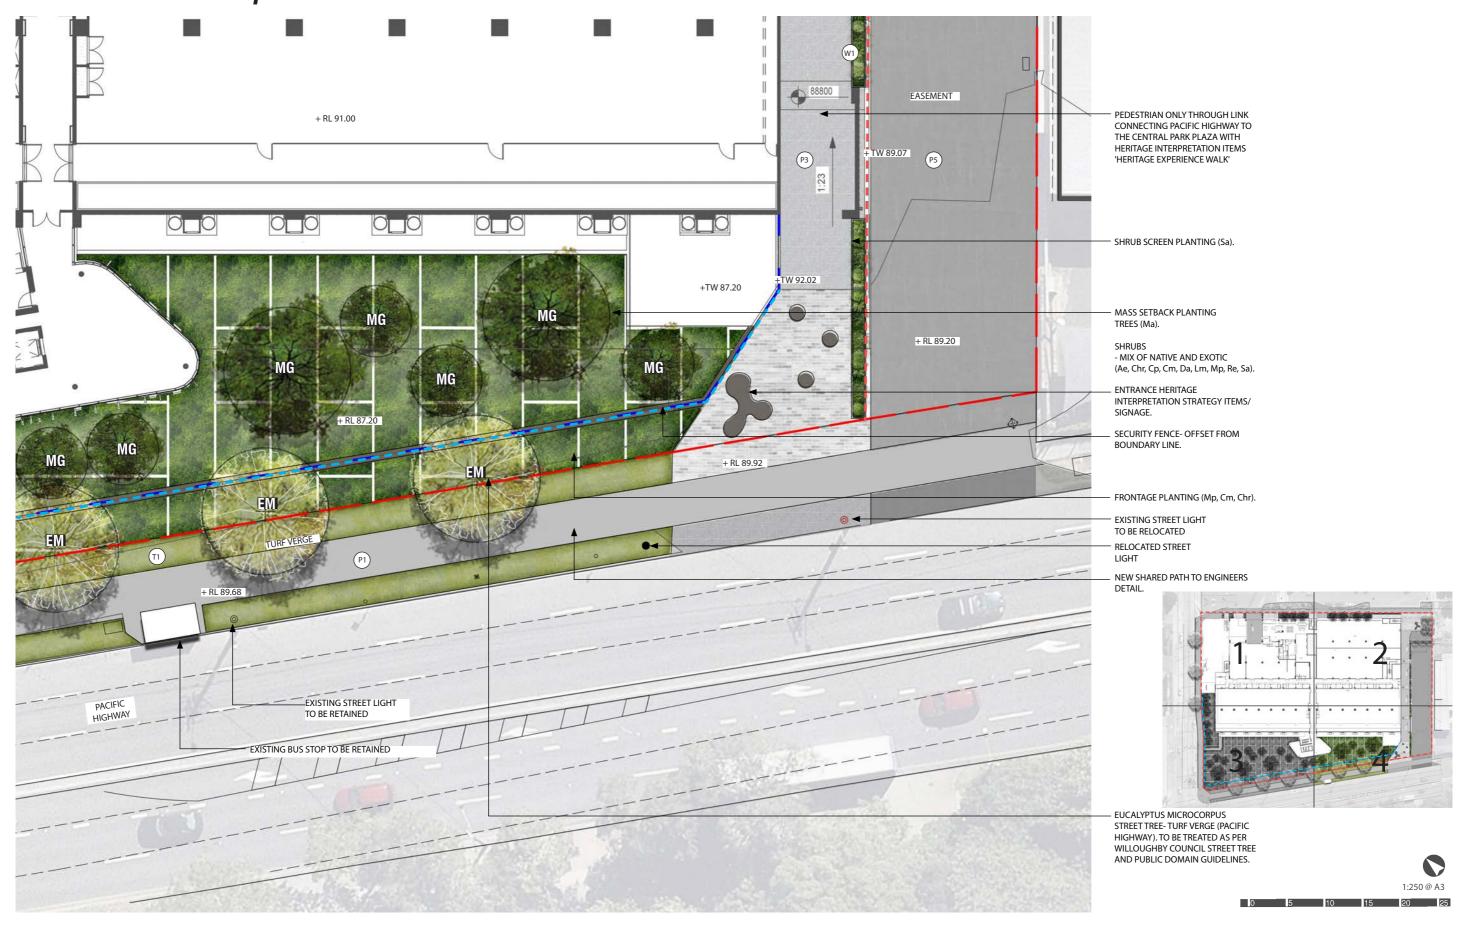

### STREET TREE AND PLANTING STRATEGY

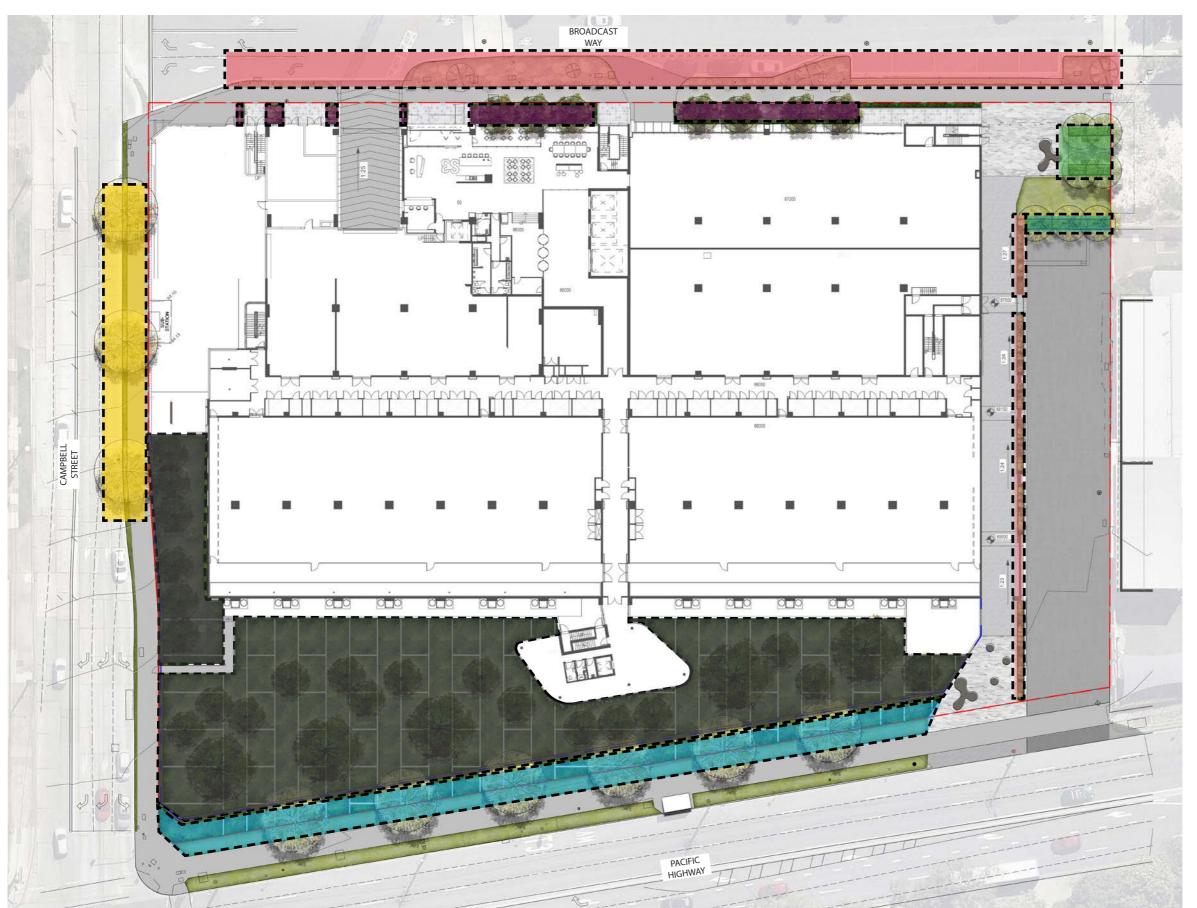





Existing Vegetation to be Retained






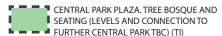




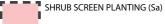

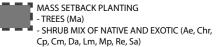



#### **PRECEDENT IMAGES**

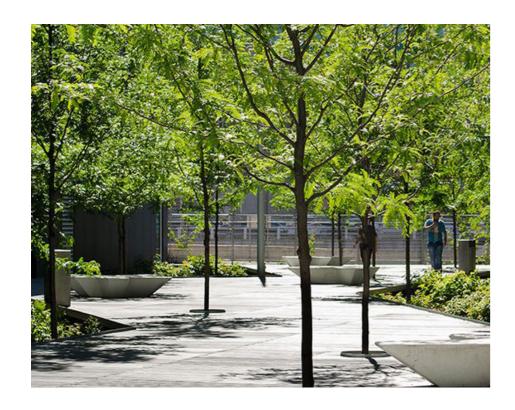











### **INDICATIVE PLANTING STRATEGY**

Plant species have been carefully chosen to form a rich pallet of size, form, colour and texture. The planting design compliments the architecture of the surrounding building particularily at the West of the building where the planting mimics the vertical structures on the building as well as creating an arbour of trees framing the view of the building.

Planting will be designed to define spaces, direct site lines, human movement, provide privacy and screening.

Street trees are informed by the special area controls for Gore Hill Technology Park as provided by Council.

Campbell Street and Pacific Highway street trees to be installed as per Council Guidelines.

Note that 70% of planted area will consist of native species to accord with Aueron Sustainability Checklist and Council's Requirements.

	Public Domain			
Code	Trees	Common Name	Mature Height x Spread (m)	Pot Size
Bi	Banksia integrifolia	Coastal Banksia	15x6	100L
Ca	Cupaniopsis anacardioides	Tuckeroo	15x15	200L
Em	Eucalyptus microcorys	Tallowwood	35x25	600L
Ер	Eucalyptus punctata	Grey Gum	35x25	600L
Mg	Magnolia grandiflora	Southern Magnolia	8x3	100L
TI	Tristaniopsis laurina	Kanooka	15x4	100L
	Shrubs + Groundcovers			
Ae	Aspidistra elatior	Cast-Iron Plant	1x1.5	200mm
Chr	Callistemon hannah ray	Bottlebrush	4x3	200mm
Ср	Cordyline petiolaris	Broad Leaved Palm Lily	4x2	200mm
Cm	Clivia miniata	Bush Lily	0.5x0.5	200mm
Da	Dichondra argentea	Light Silver Leaved Accent Plant	0.8x1.2	140mm
Lm	Liriope muscari	Lily Turf	1x1	200mm
Мр	Murraya paniculata	Mock Orange	2.5x1.2	200mm
Re	Rhapis excelsa	Broadleaf Lady Palm	4 x 2	200mm
Sa	Syzygium australe	Brush Cherry	5x2.5	200mm

## **INDICATIVE PLANTING PALETTE**

TREES (STREETS + PRIVATE)
































## **HERITAGE INTERPRETATION STRATEGY**

In coordination with the Urbis Heritage team a Heritage Interpretation Strategy has been developed which serves as a display for the previous use of the site. The interpretation elements are located together, down the Eastern side of the site ensuring the narrative of the sites history is read together in a coherent order and maximises the users understanding of the site and its history.

This Heritage Interpretation Strategy is envisioned as a signage or sculptural heritage item at the entrance of the through link on Pacific Highway and within the central park plaza along Broadcast Way. As well as the use of paving motifs, lighting and site markers down the through link that take the user on an experience through the site informing them of the sites history and significance, aiming to give the idea that this place is something 'special'.

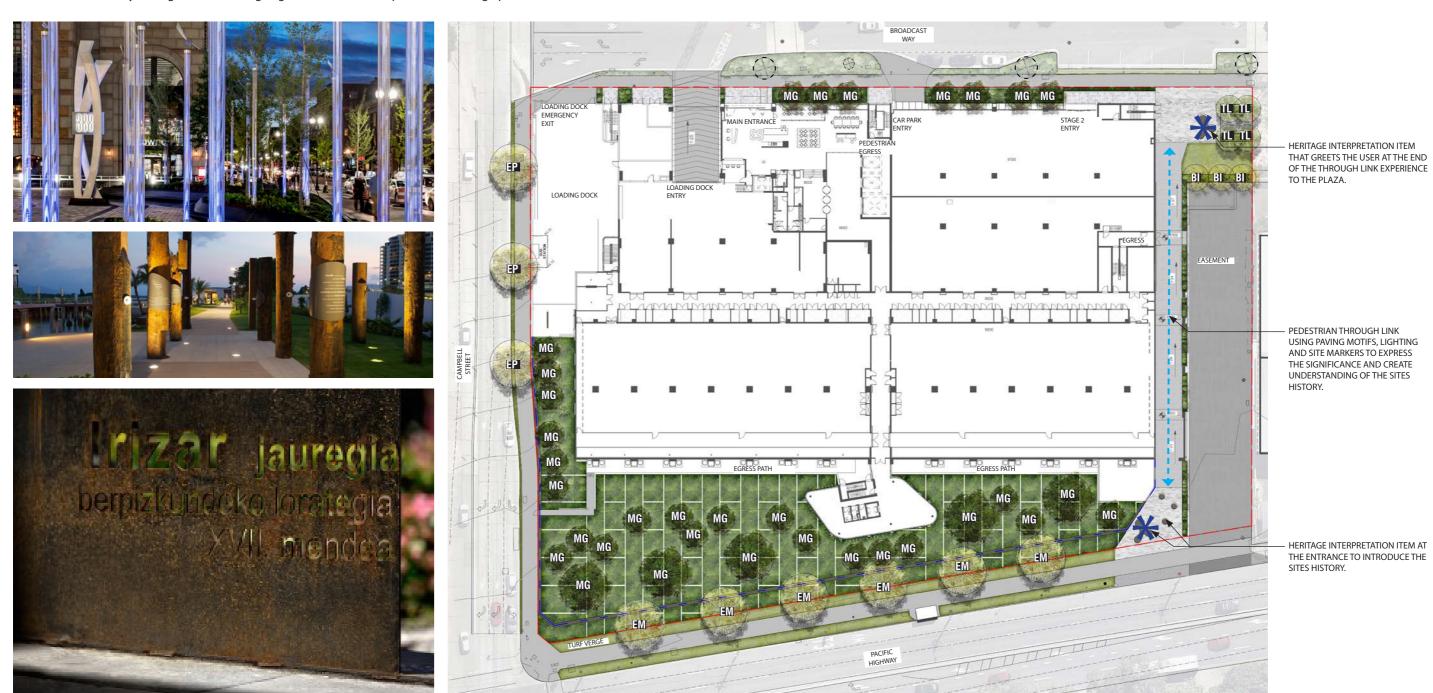

### **MATERIALS STRATEGY**

All paving materials and street furniture would be subject to relevant Australian Standards and comply with City of Willoughby Council's DCP.

Paving will consist of contrasting finishes, textures and materials. Paving sizes and textures will delineate public spaces and accentuate common entrance points and pedestrian linkages. Refer to engineers drawings for finishes of driveways.



In-situ Concrete Paving (with nature verge) -Streetscape

- Natural grey
- Broom finish



Concrete Unit Paving - Loby Entries

- Flame Exfoliated
- 300 x 150 x 40mm



Large Concrete Unit Paving - Through Link

- Flame Exfoliated
- 600 x 300 x 60mm



Small Concrete Unit Paving - Plaza Entrance

- Flame Exfoliated
- 200 x 150 x 40mm



Bitumen Road Surface




Sir Walter Soft Leaf Buffalo Turf








## **LANDSCAPE DETAIL SECTIONS**

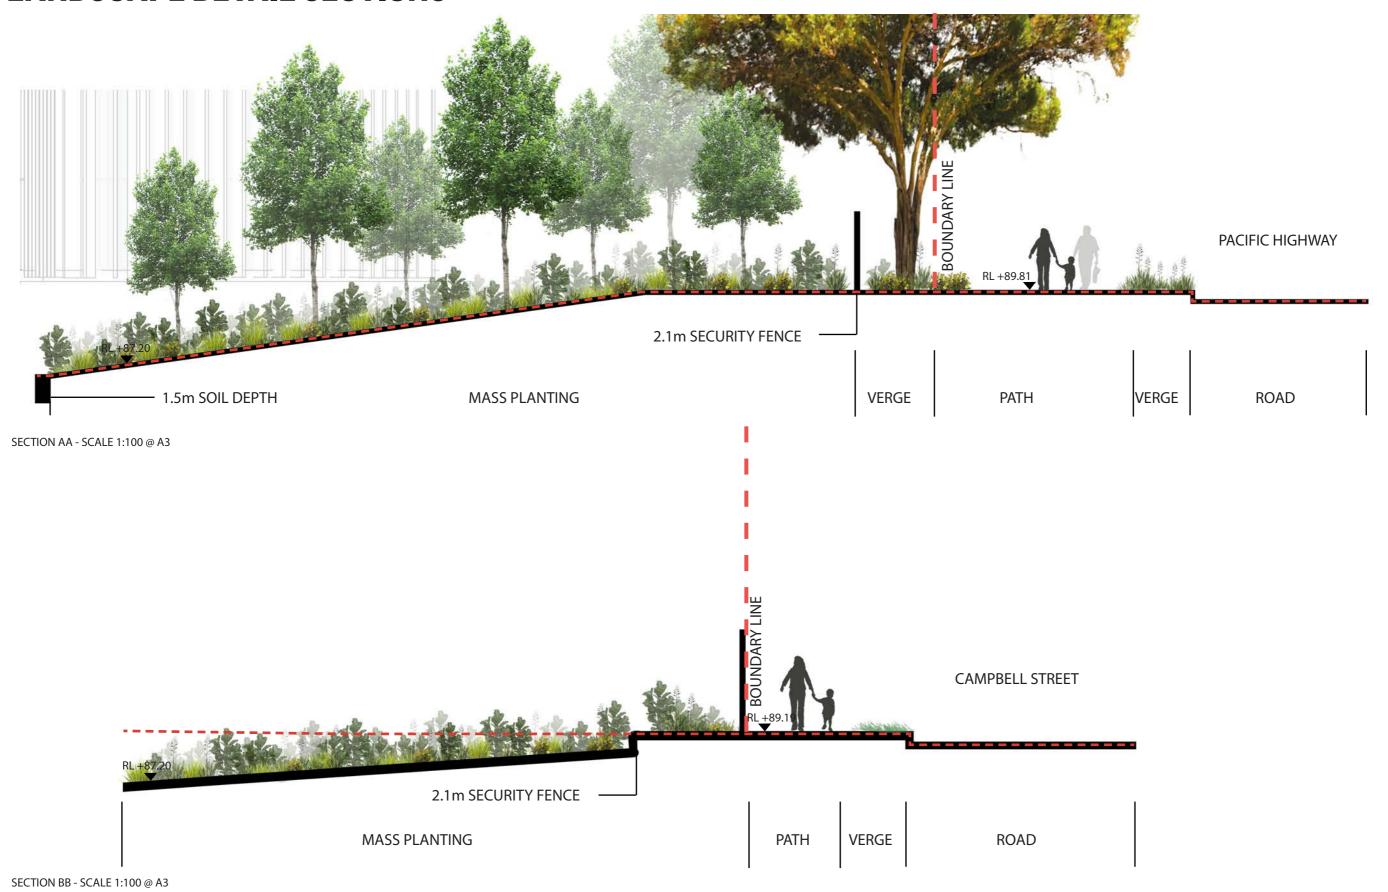


## **LANDSCAPE DETAIL SECTIONS**

SECTION CC - SCALE 1:100 @ A3

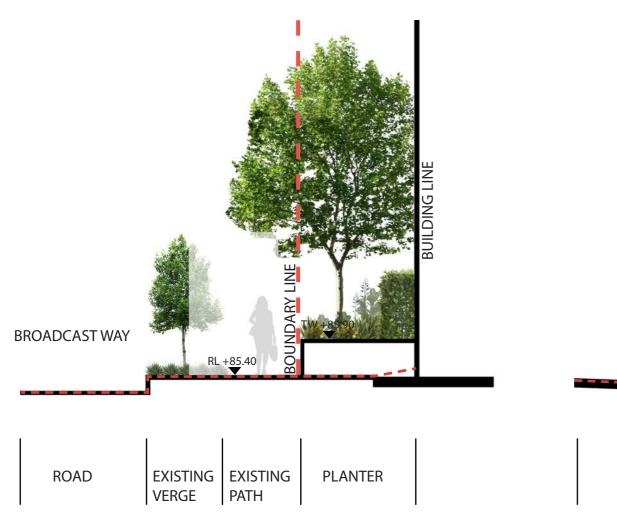

PLANTER PEDESTRIAN THROUGH LINK **EASEMENT** 

SECTION DD - SCALE 1:50 @ A3

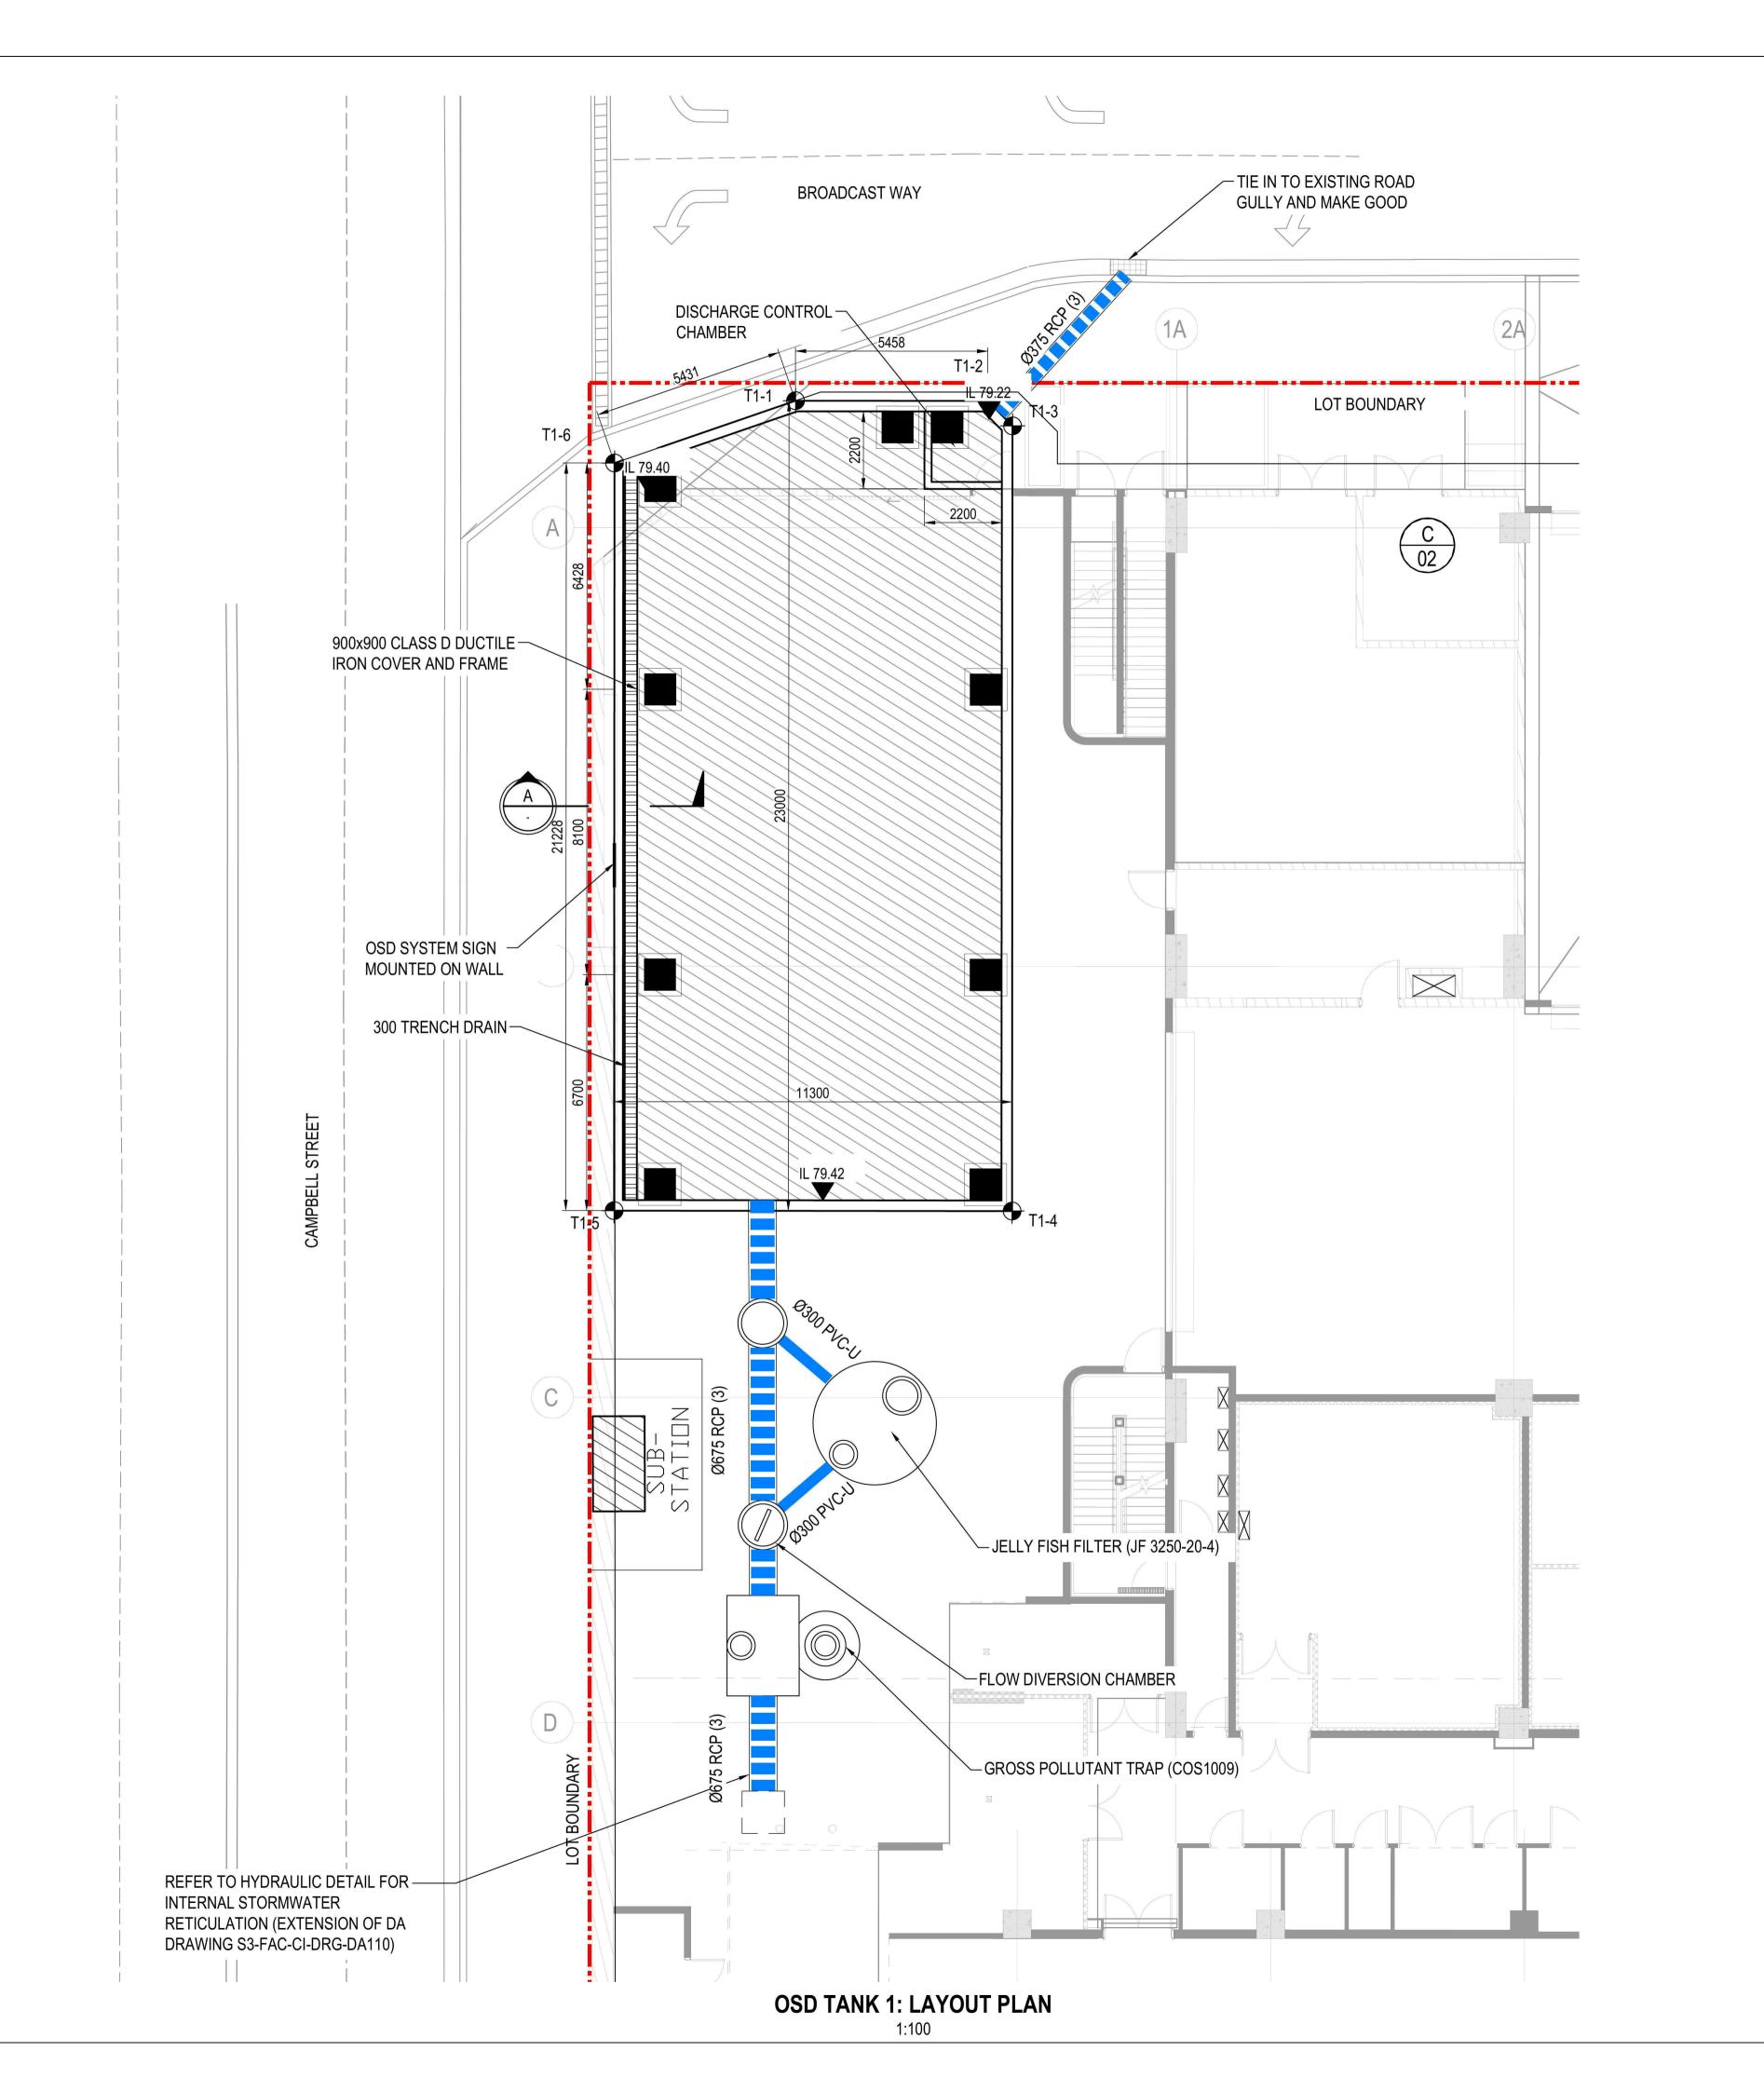


ra-				
OSD TANK 1 SETOUT				
POINT	EASTERN	NORTHERN		
T1-1	331983.2	6256489.8		
T1-2	331986.1	6256485.2		
T1-3	331985.9	6256484.2		
T1-4	331967.0	6256472.4		
T1-5	331961.0	6256482.0		
T1-6	331979.0	6256493.2		

### NOTES:


1. REFER TO STRUCTURAL DRAWINGS FOR TANK DETAIL AND REINFORCEMENT.


2. REFER TO HYDRAULIC DRAWING FOR ROOF AND SITE DRAINAGE DETAIL.

3. OSD SYSTEM SIGN TO BE 400mm x 200mm ALMINIUM PLAQUE WITH WORDING: "This is the on- site stormwater detention system required by Willoughby City Council. It us an offence to alter any part of the system without written consent from Council. The registered proprietor shall keep the system in good working order by regular maintenance including removal of debris."

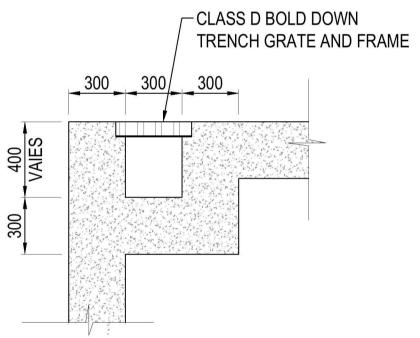



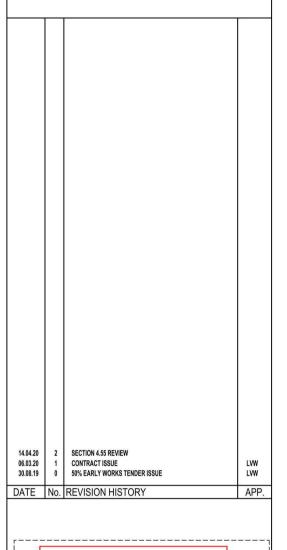

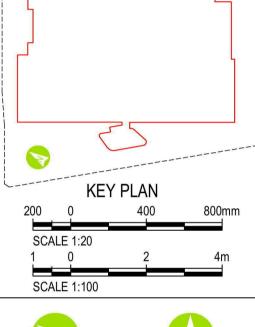



NEXTDC S3
Lot 6 219-247 Pacific
Highway, Artarmon


SYDNEY




CONTRACT ISSUE
NOT FOR CONSTRUCTION

CIVIL ENGINEERING SERVICES STORMWATER OSD TANK 1 LAYOUT PLAN

2	-00-330	S3-FAC-CI-D
rev		dwg no
	approved: L.VAN WYK	checked: L.VAN WYK
	T.HOANG	P.LE
	designed:	drawn:
A1	1:100	503243
91.9	scale:	project no:

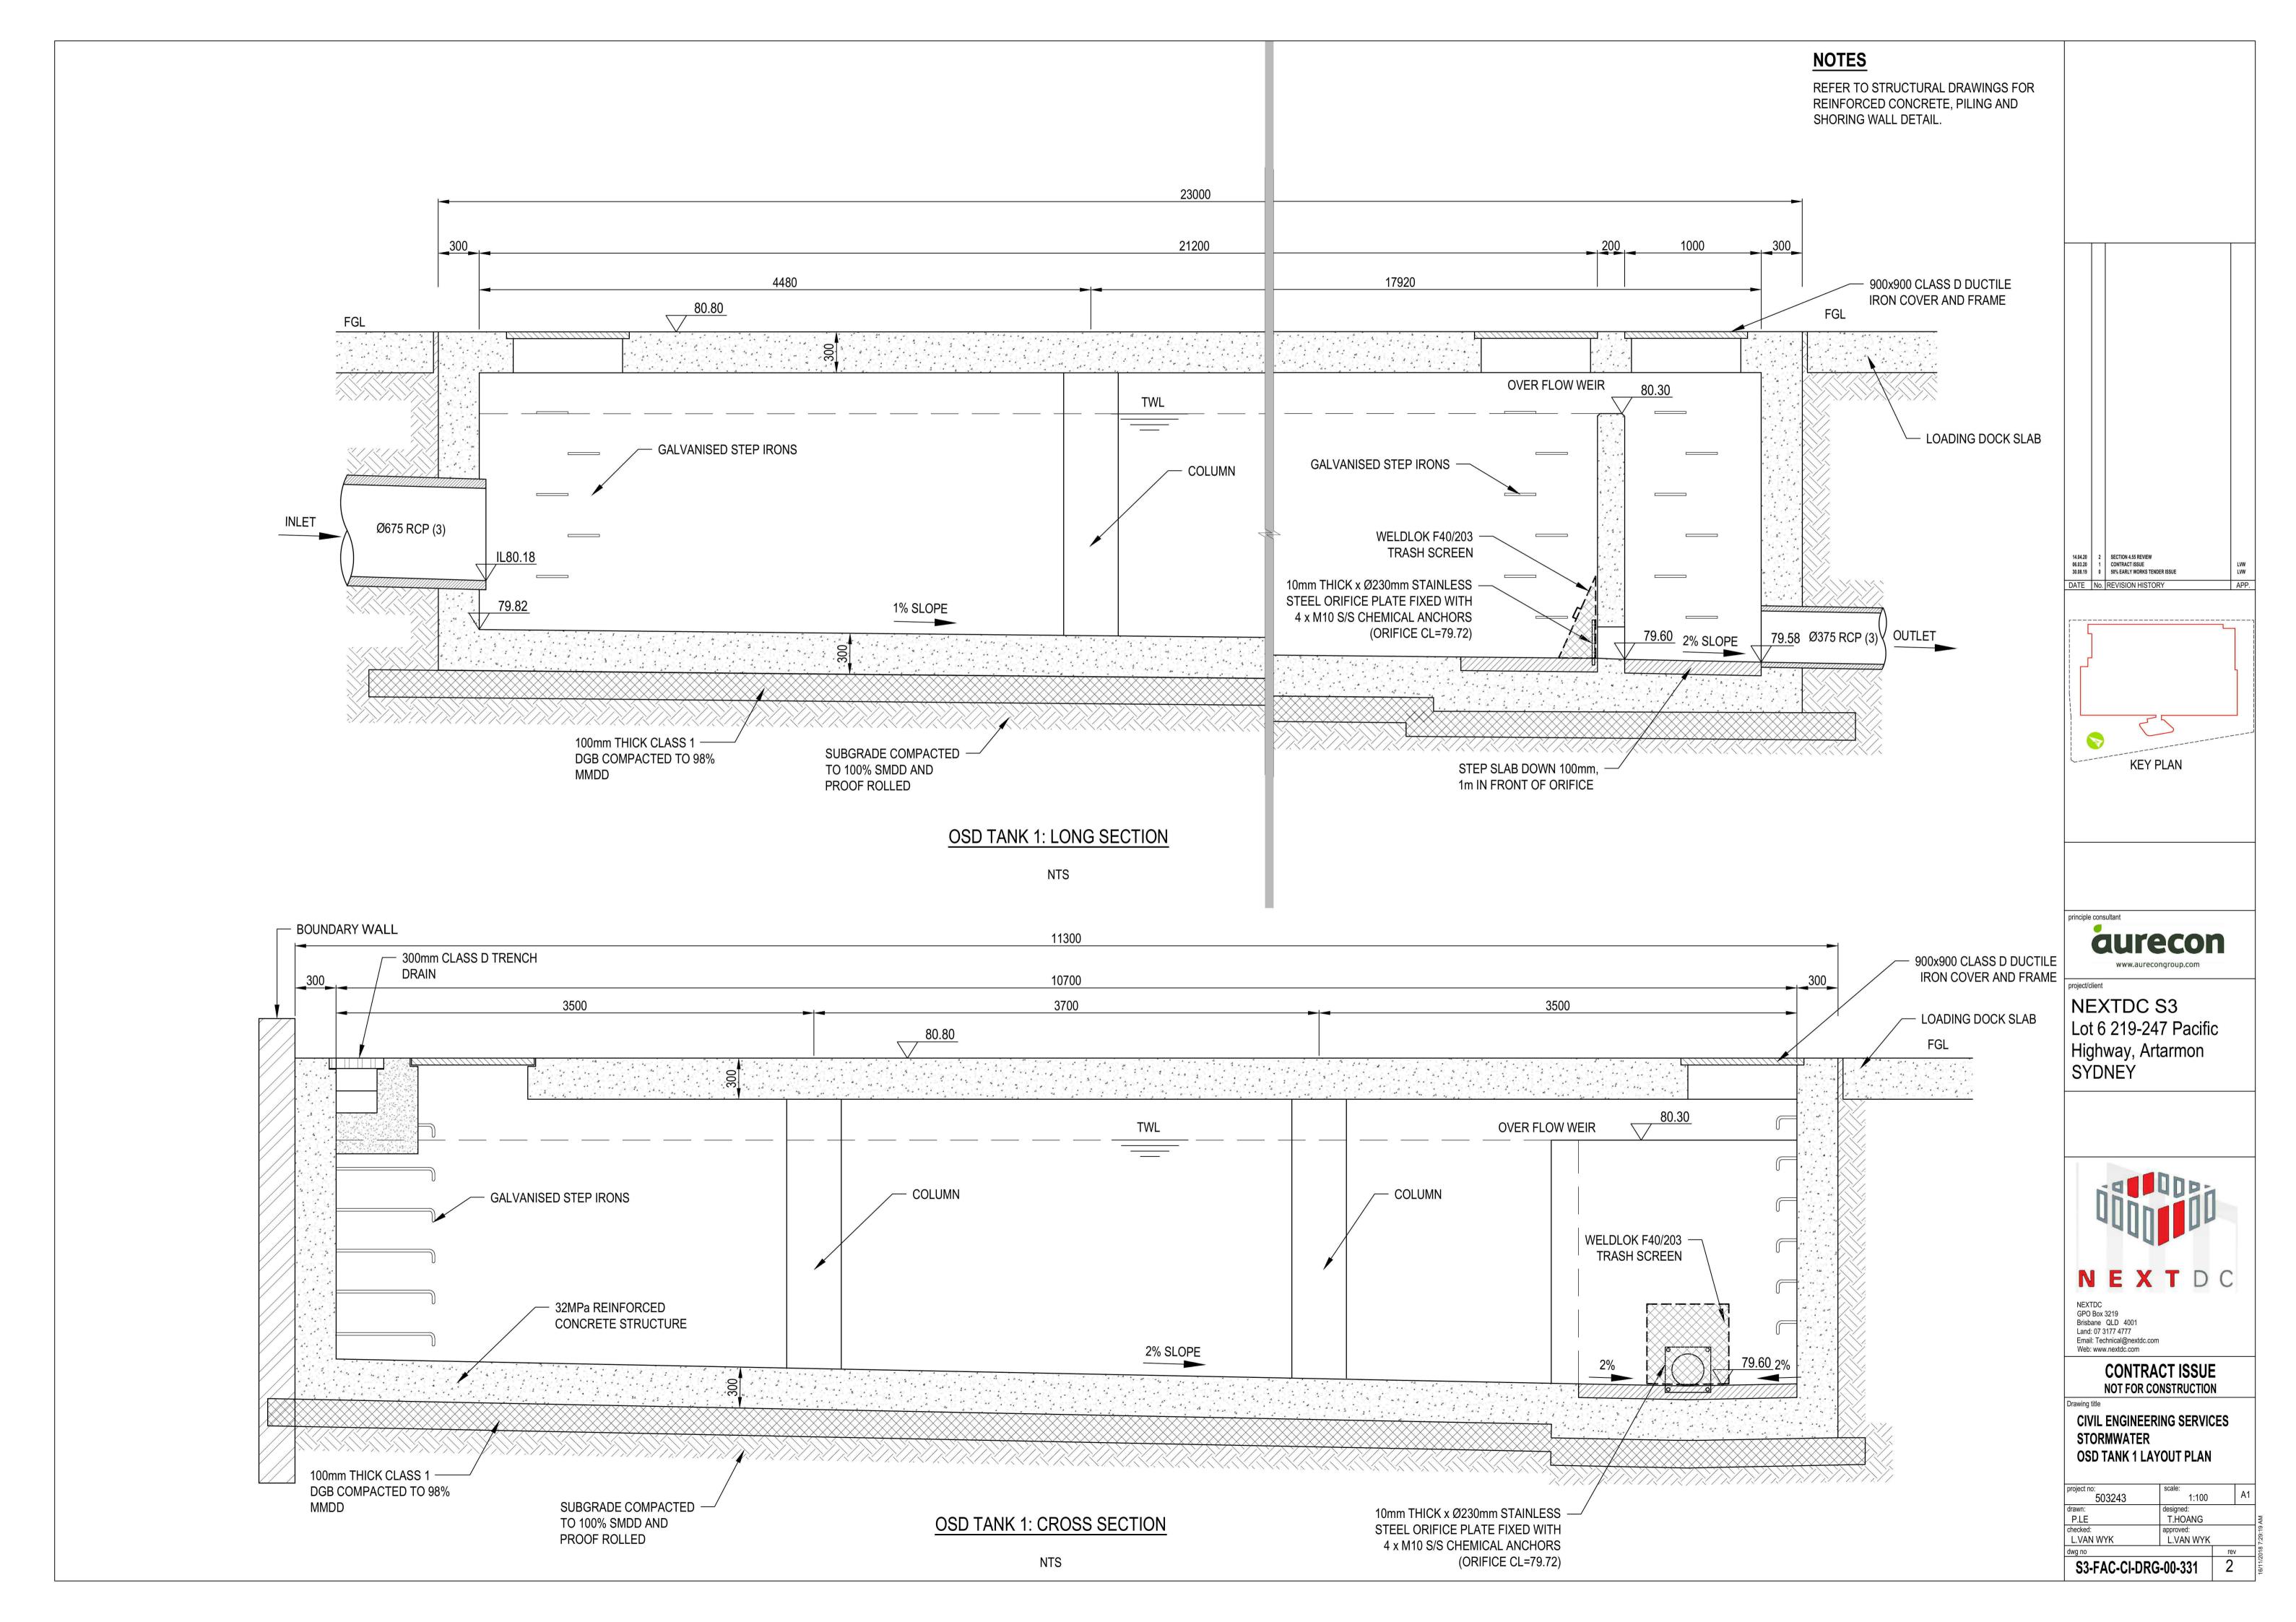


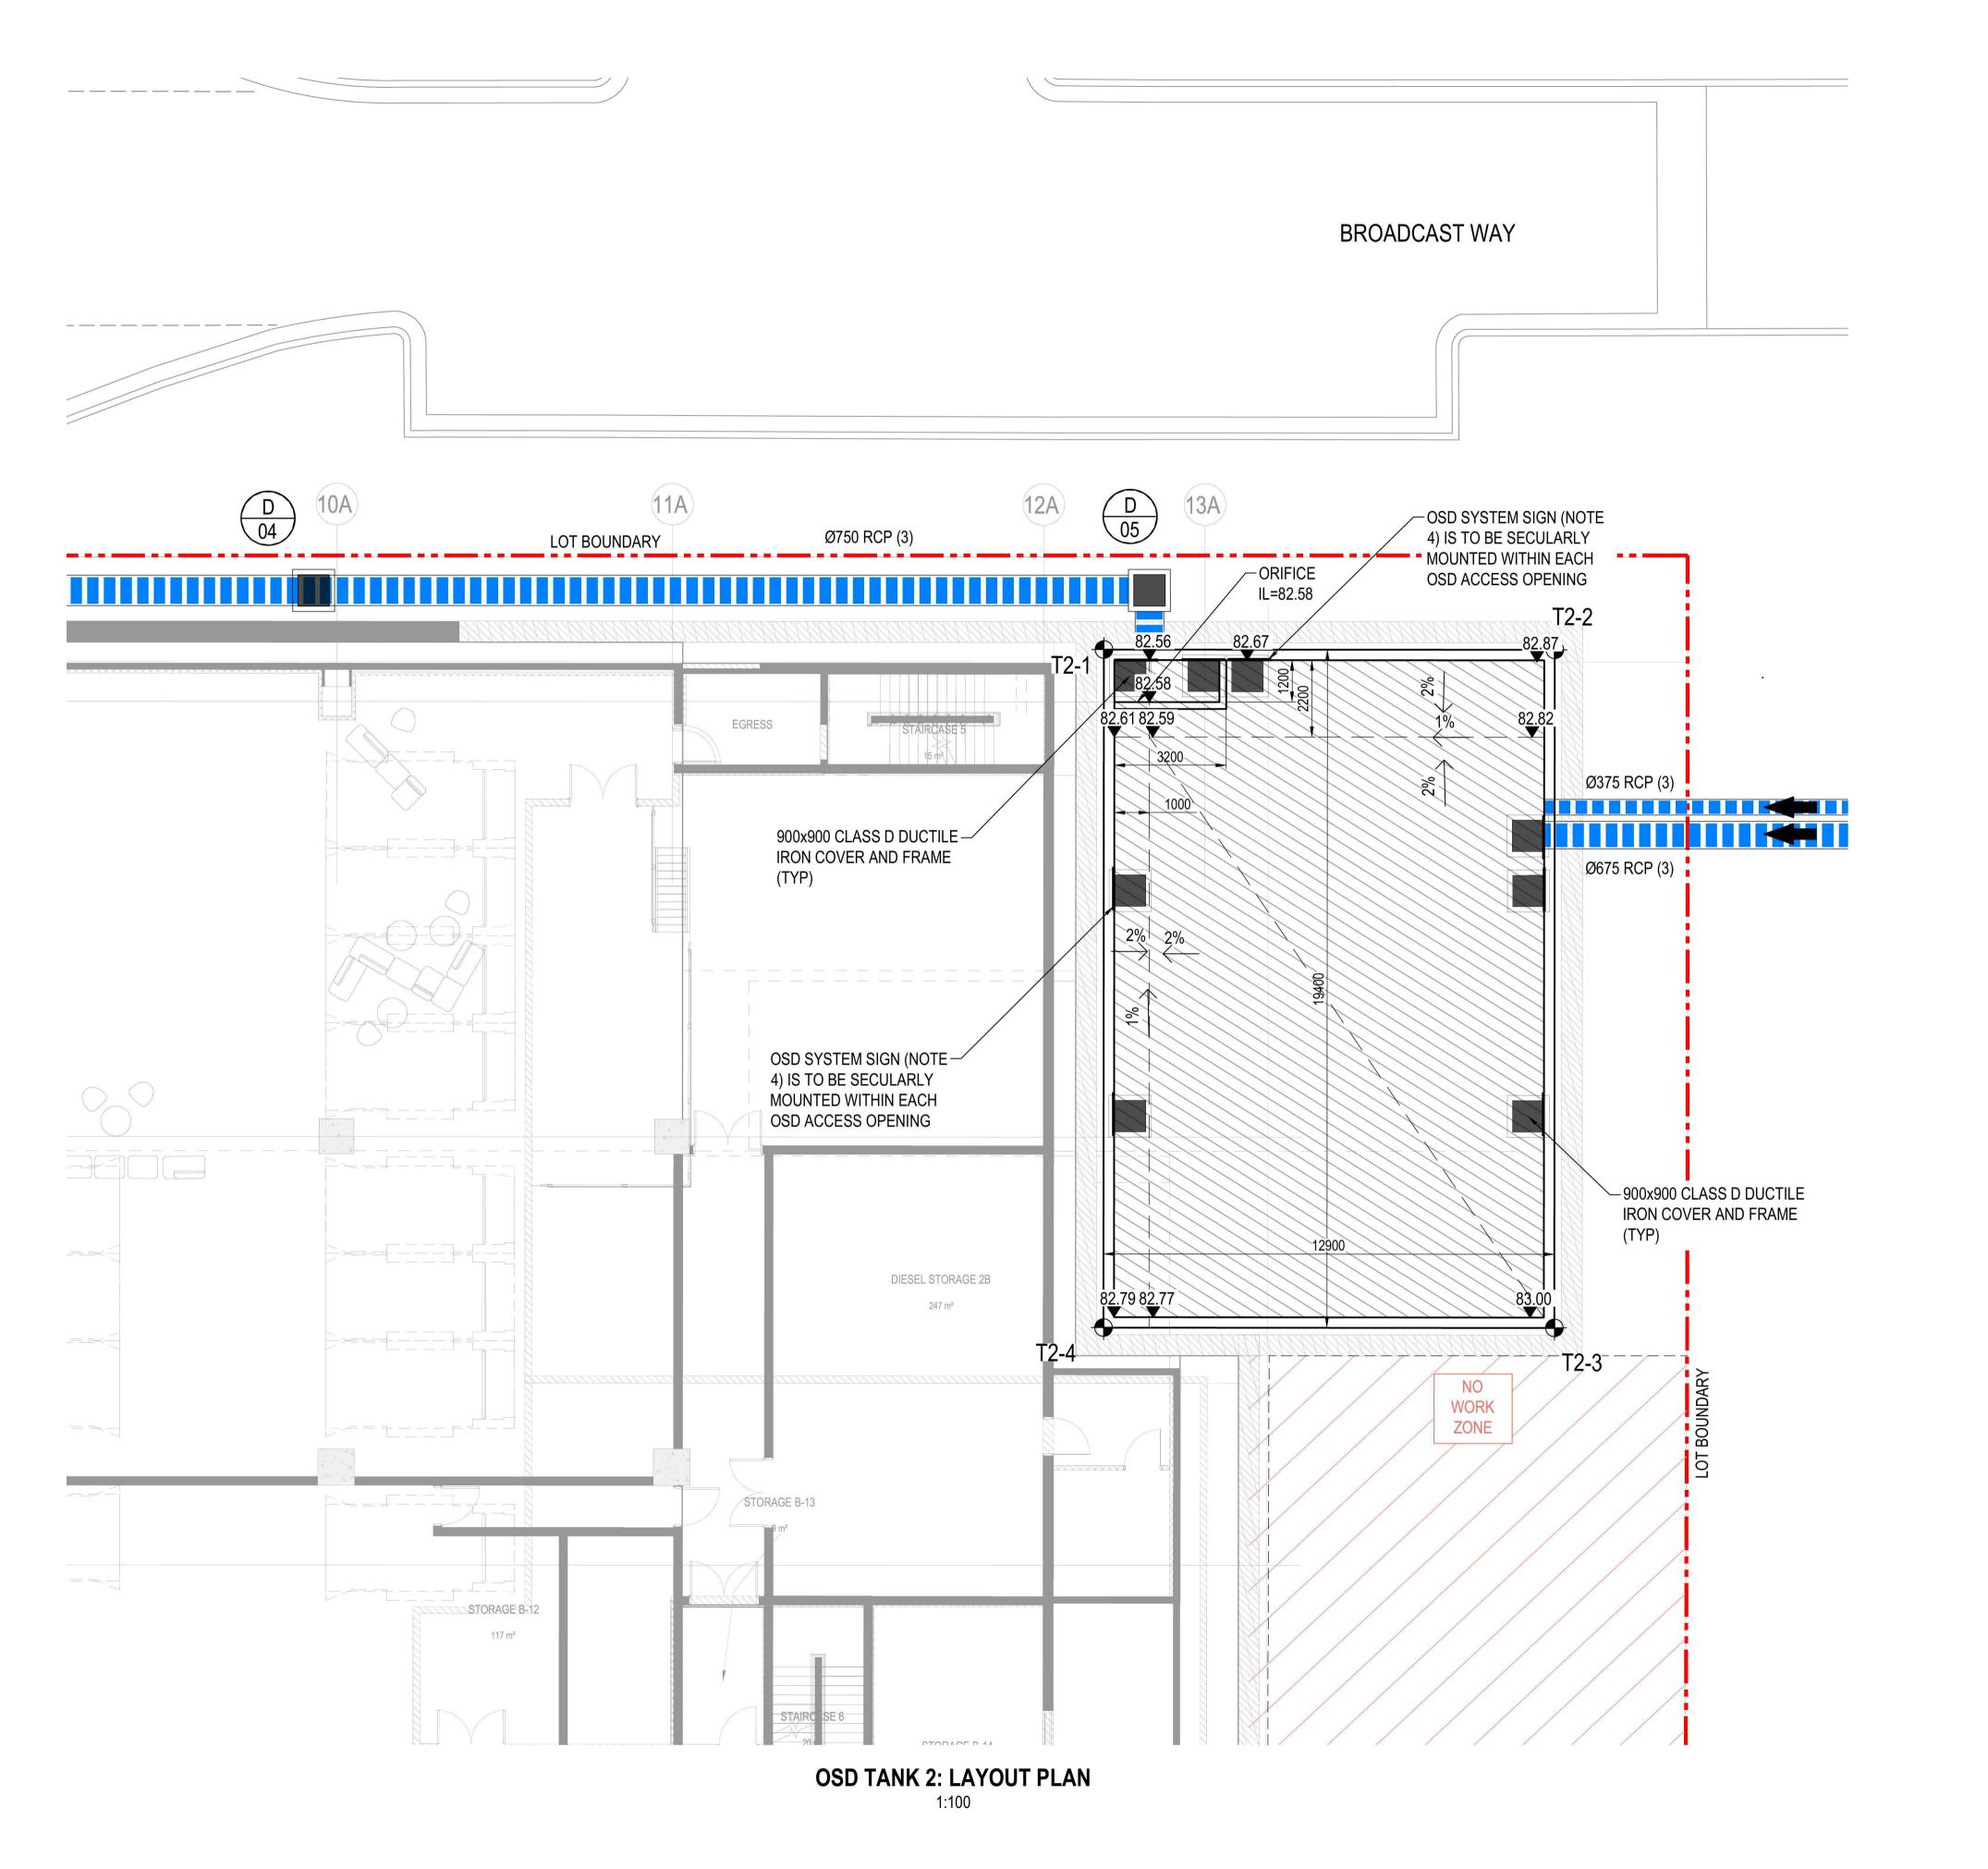



OSD TANK I SETOUT			
POINT	EASTERN	NORTHERN	
T2-1	332041.0	6256393.4	
T2-2	332047.8	6256382.4	
T2-3	332031.4	6256372.2	
T2-4	332024.5	6256383.1	

#### NOTES:

- 1. THE CONTRACTOR IS TO ALLOW FOR THE OSD TANK TO BE COORDINATED WITH THE STRUCTURAL AND ARCHITECTURAL DOCUMENTATION.
- 2. REFER TO STRUCTURAL DRAWINGS FOR TANK DETAIL AND REINFORCEMENT.
- 3. REFER TO HYDRAULIC DRAWING FOR ROOF AND SITE DRAINAGE DETAIL.
- 4. OSD SYSTEM SIGN TO BE 400mm x 200mm ALUMINIUM PLAQUE WITH WORDING: "This is the on- site stormwater detention system required by Willoughby City Council. It us an offence to alter any part of the system without written consent from Council. The registered proprietor shall keep the system in good working order by regular maintenance including removal of debris."

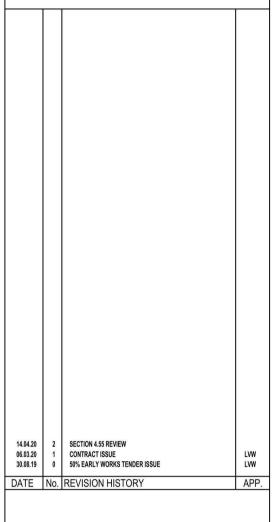


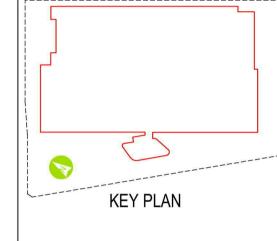

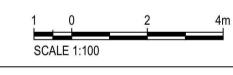




principle consultant

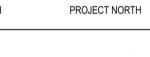

aurecongroup.com

project/client

NEXTDC S3 Lot 6 219-247 Pacific Highway, Artarmon SYDNEY

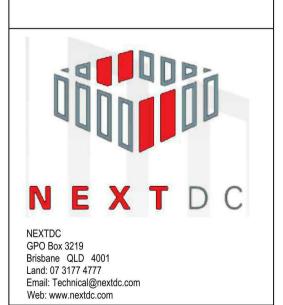


CONTRACT ISSUE
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CIVIL ENGINEERING SERVICES STORMWATER OSD TANK 2 LAYOUT PLAN


S3-FAC-CI-D	RG-00-335	2	
dwg no		rev	/
checked: L.VAN WYK	approved: L.VAN WYK		
P.LE	T.HOANG		
drawn:	designed:		Ī
503243	1:100		A1
project no:	scale:		000

#### **NOTES**


REFER TO STRUCTURAL DRAWINGS FOR REINFORCED CONCRETE, PILING AND SHORE WALL DETAIL.

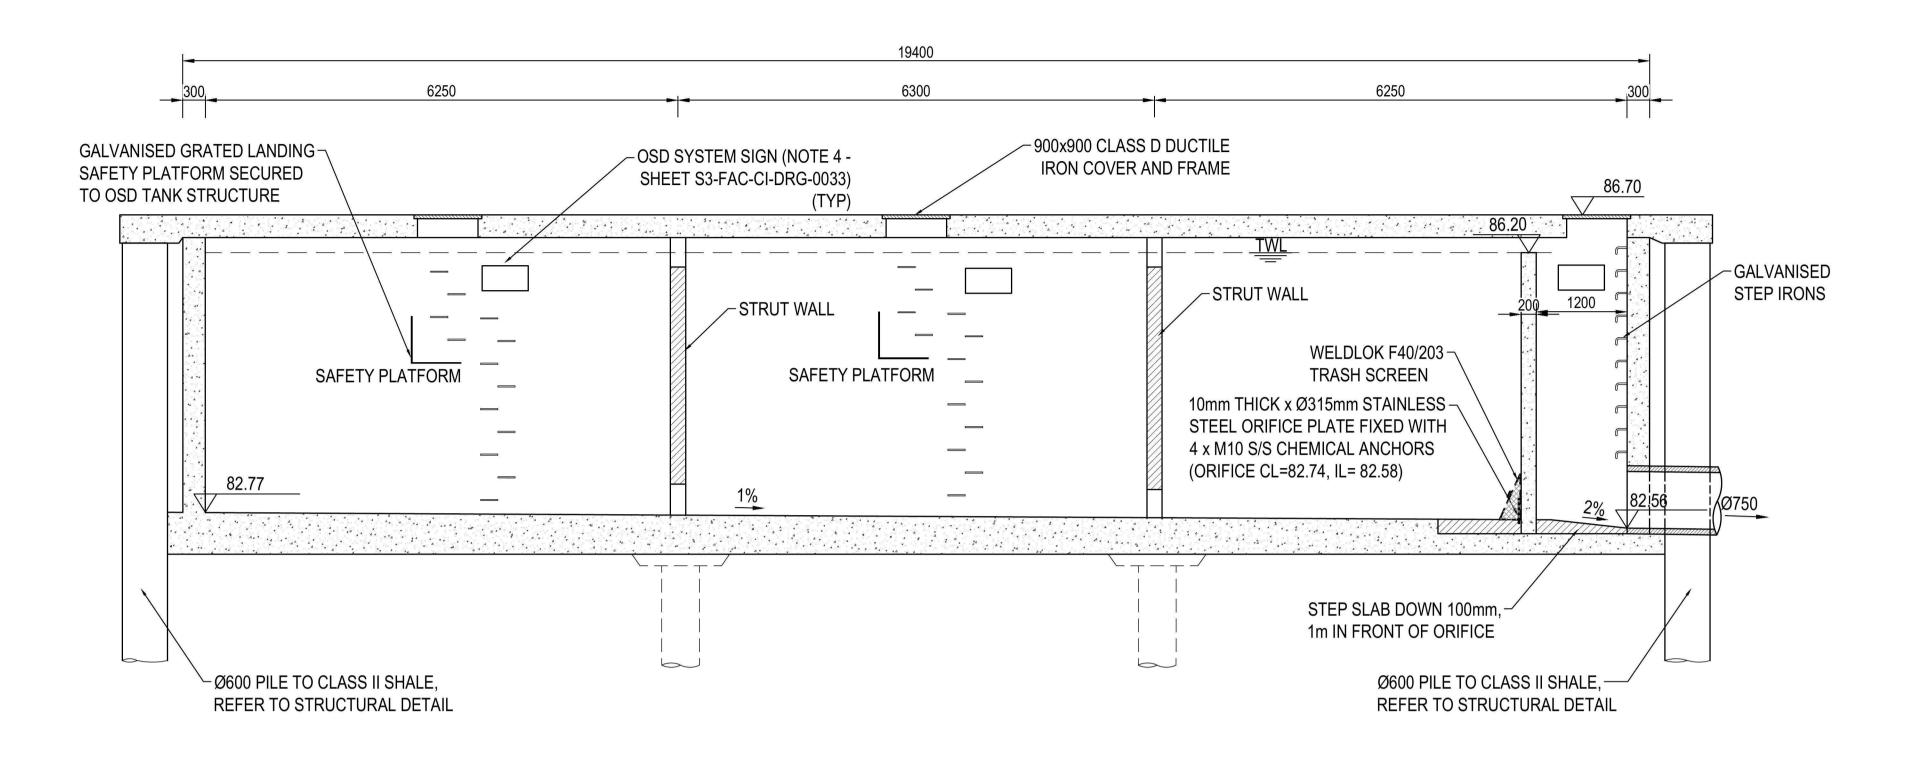


OSD TANK 2 : LONG SECTION NTS

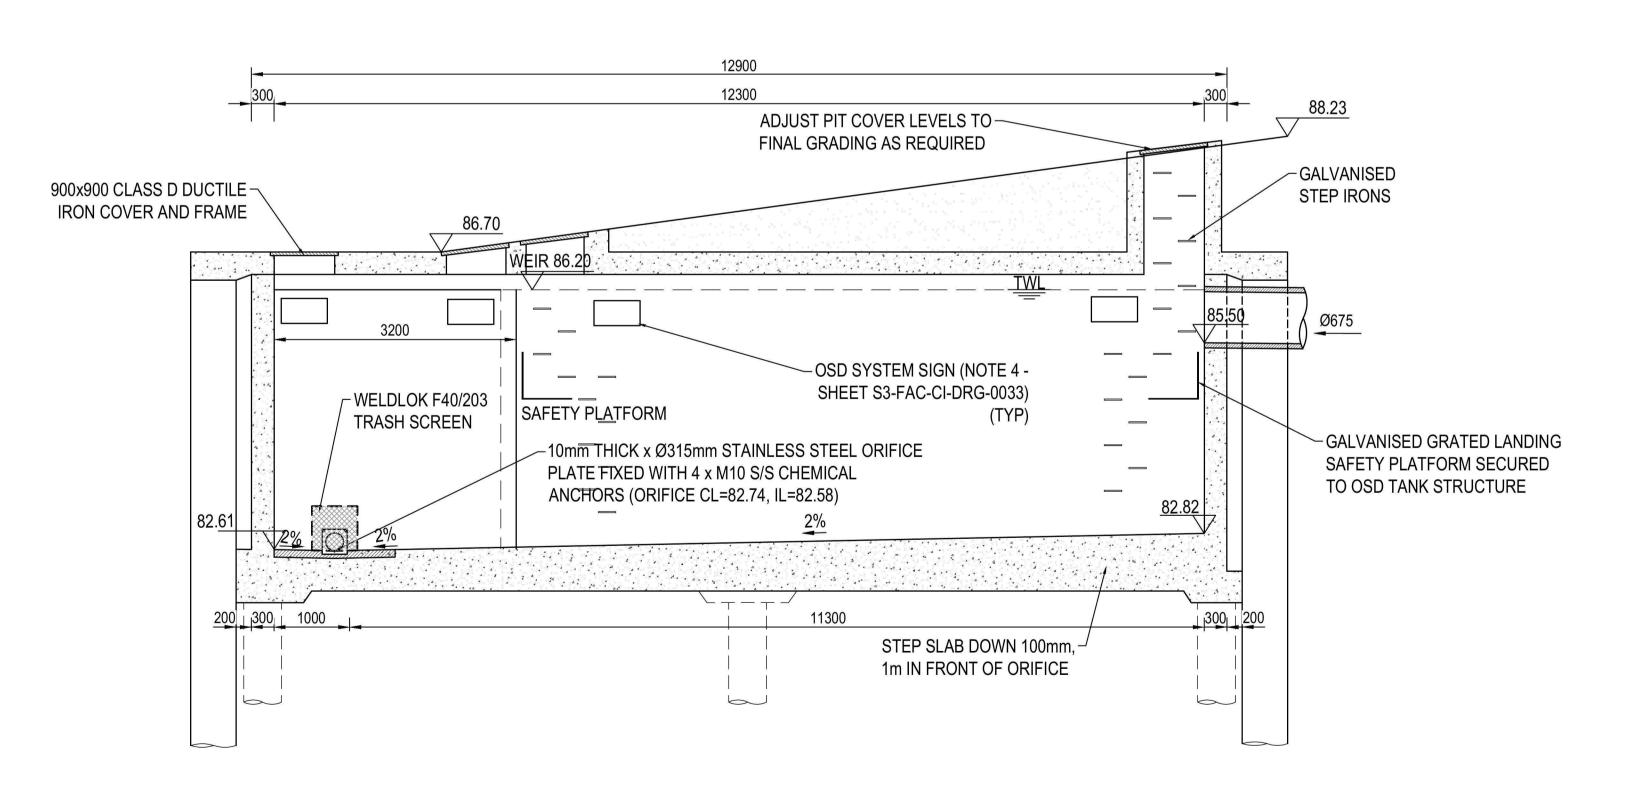

OSD TANK 2 : CROSS SECTION NTS

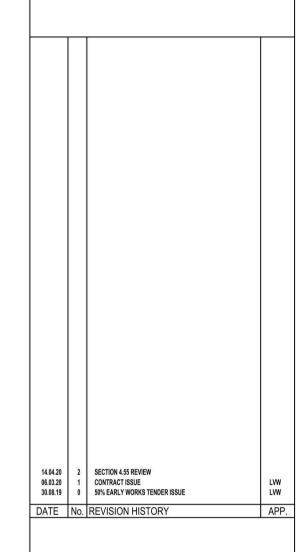

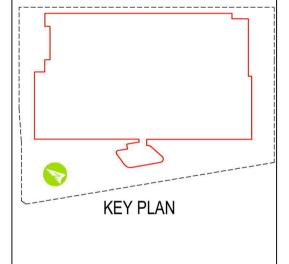




NEXTDC S3
Lot 6 219-247 Pacific
Highway, Artarmon
SYDNEY





CONTRACT ISSUE
NOT FOR CONSTRUCTION

CIVIL ENGINEERING SERVICES STORMWATER OSD TANK 2 SECTIONS

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dwg no		rev	/
checked: L.VAN WYK	approved: L.VAN WYK		
P.LE	T.HOANG		
drawn:	designed:		
project no: 503243	scale:		A1

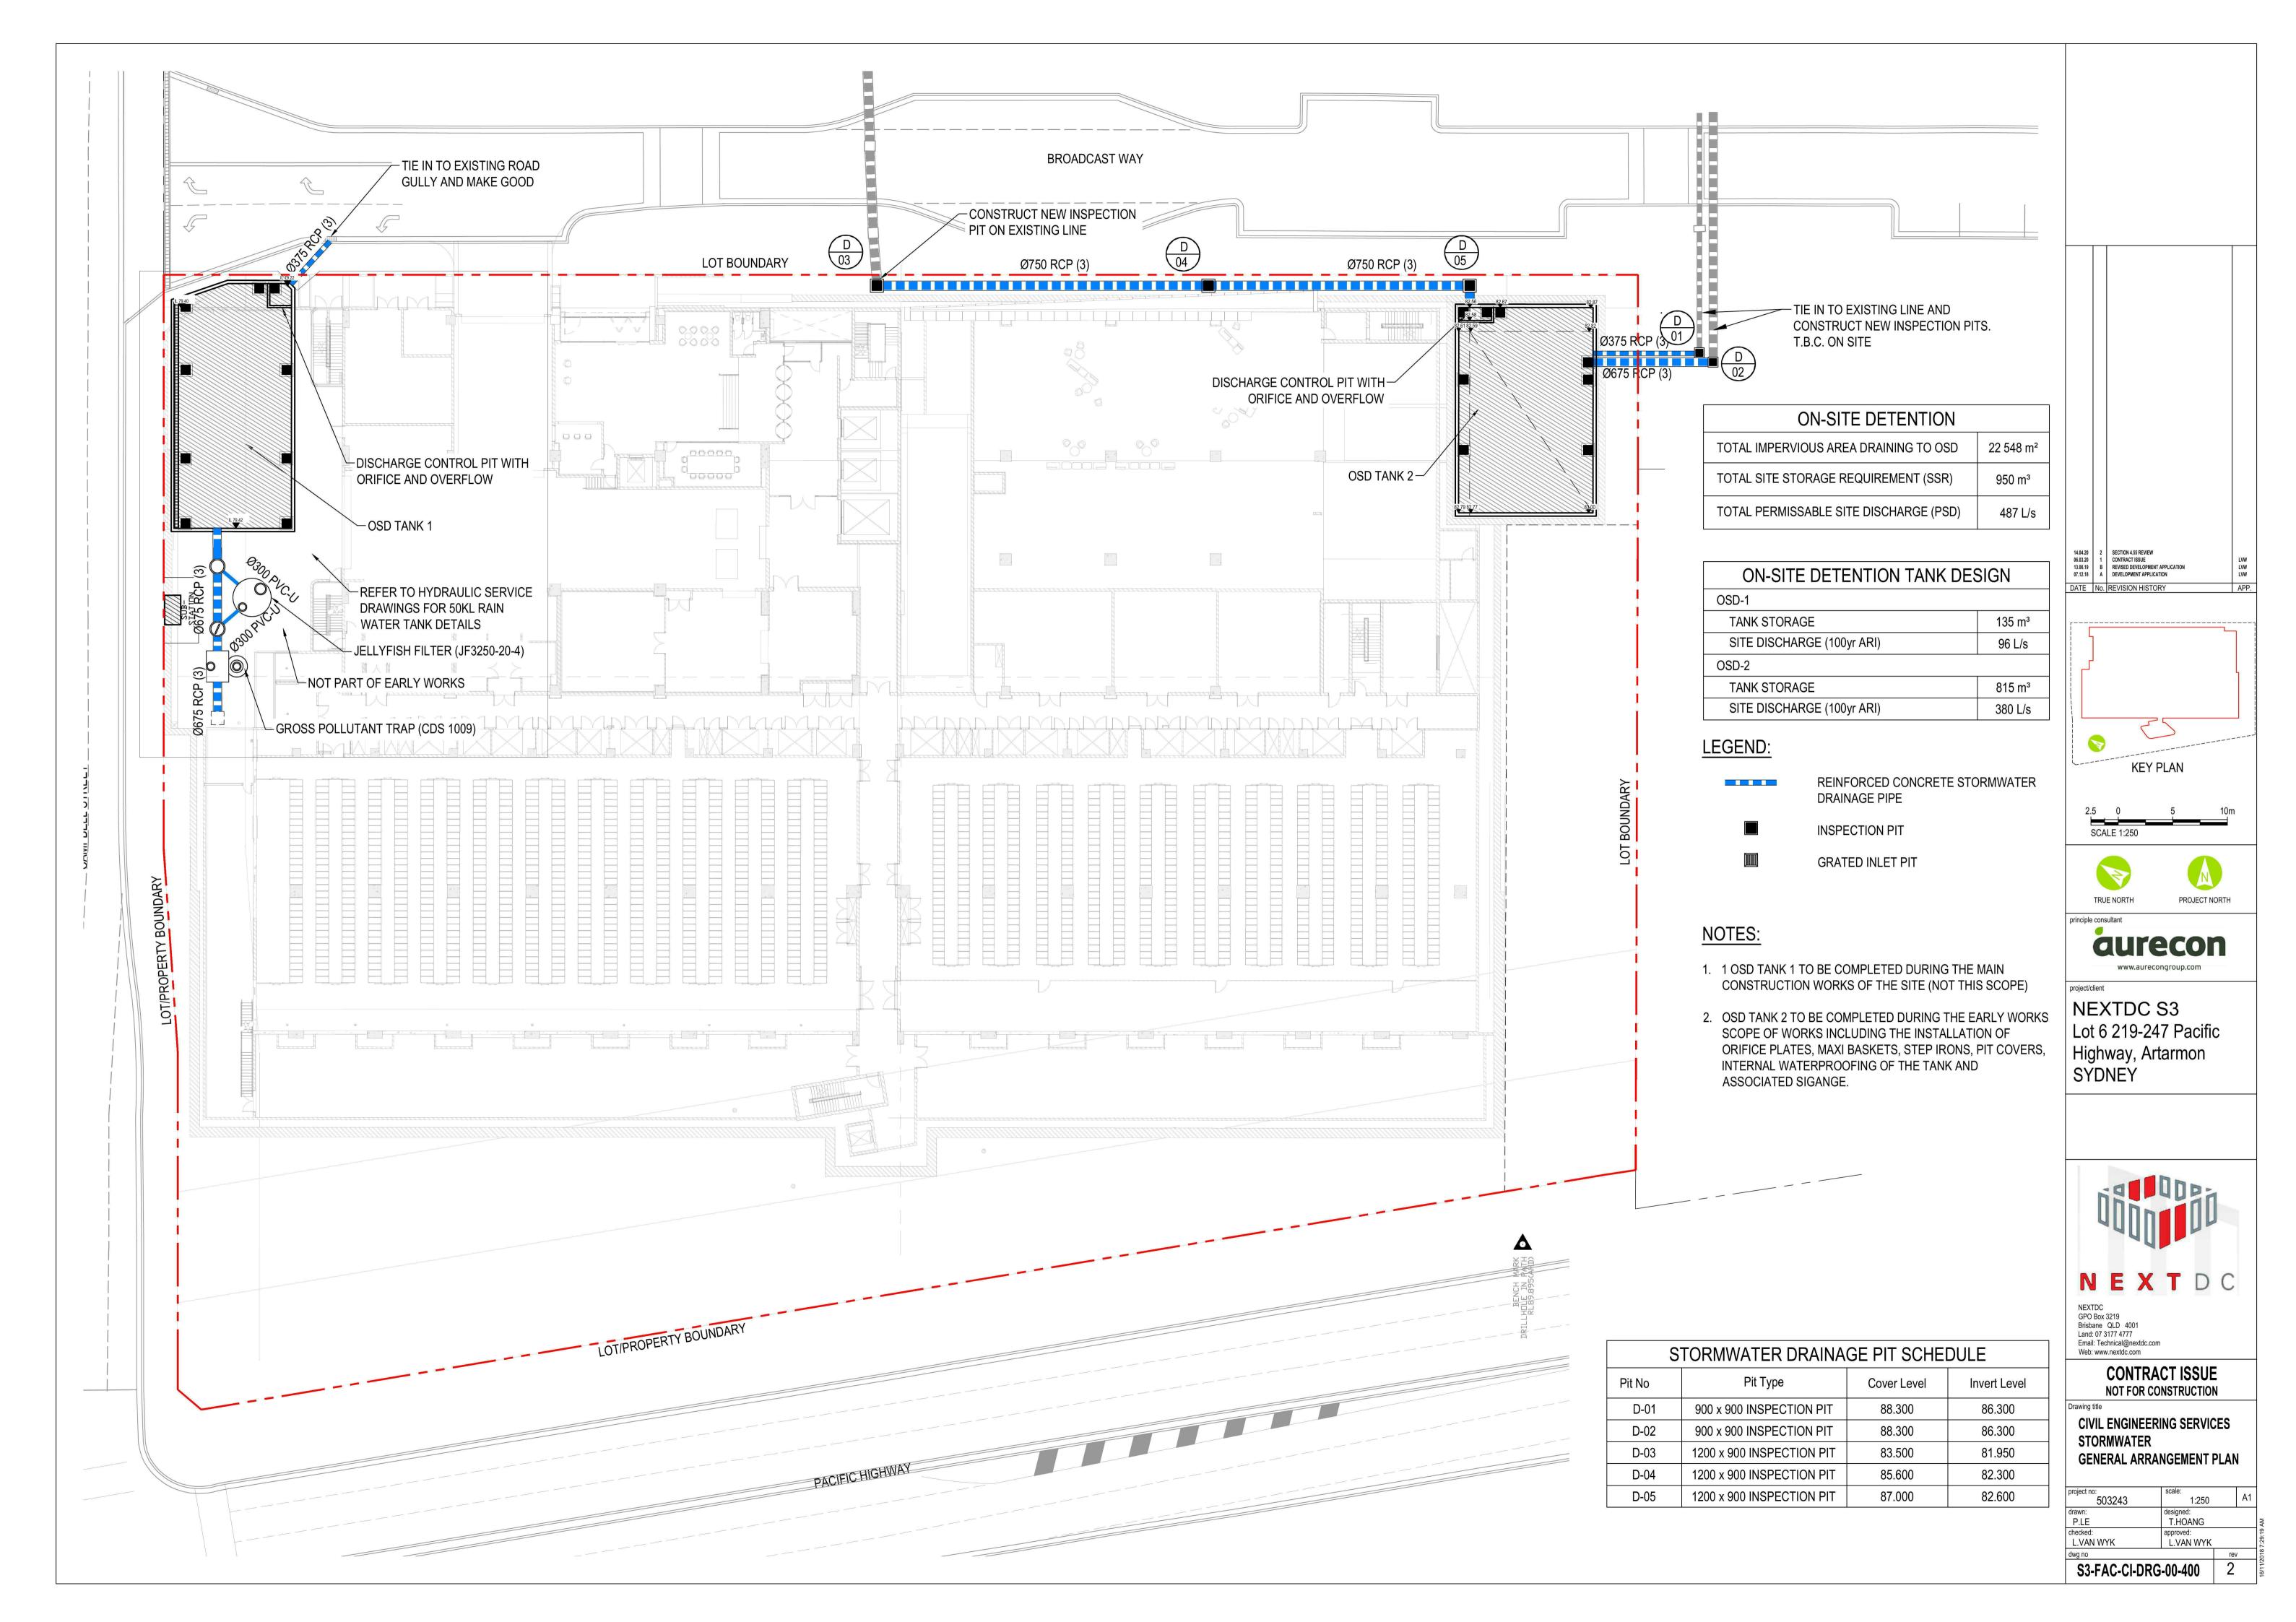

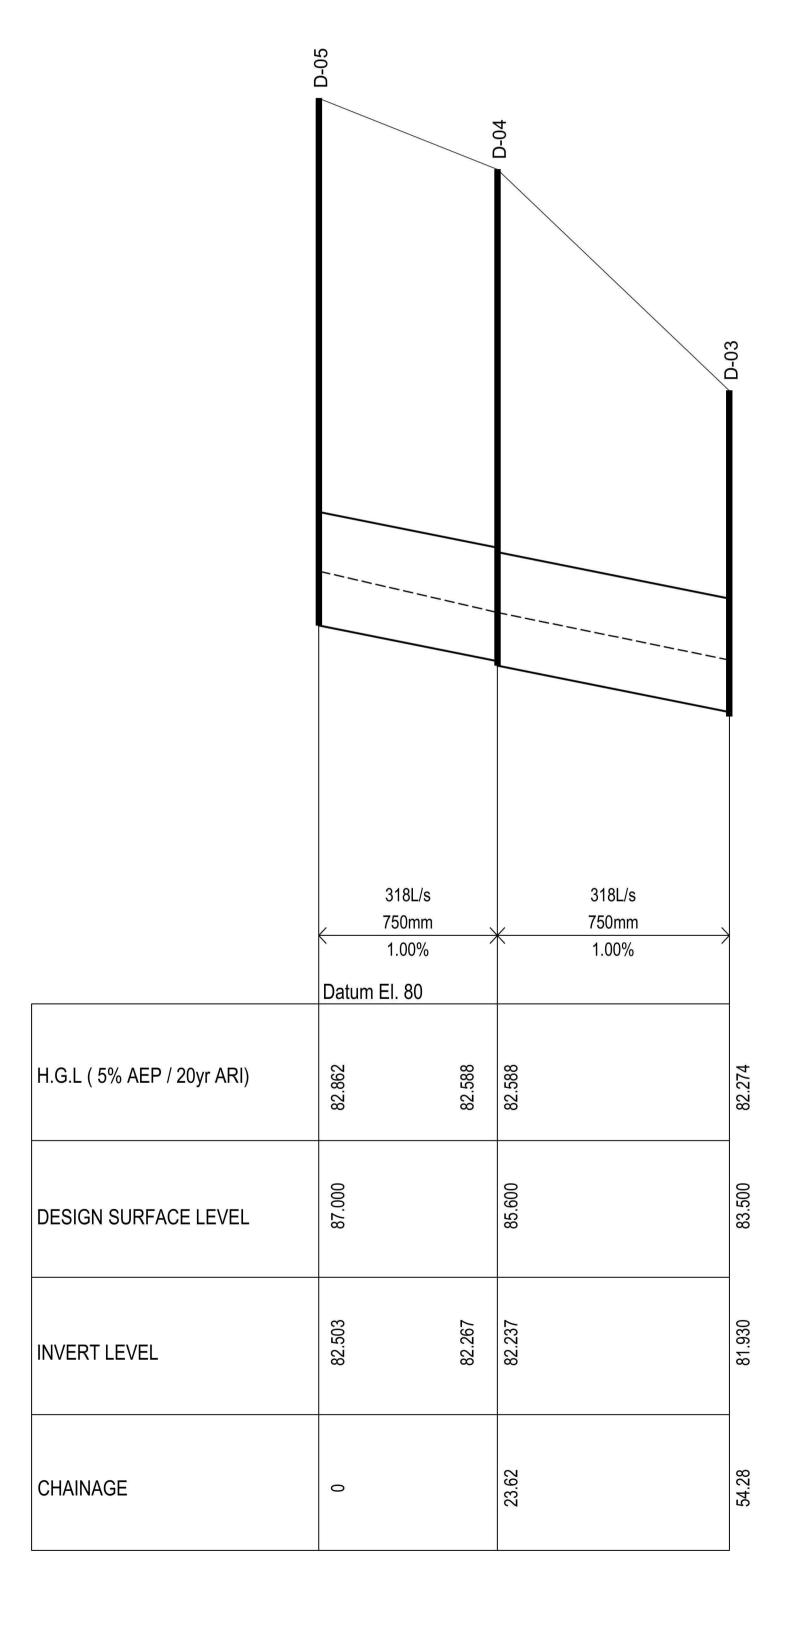

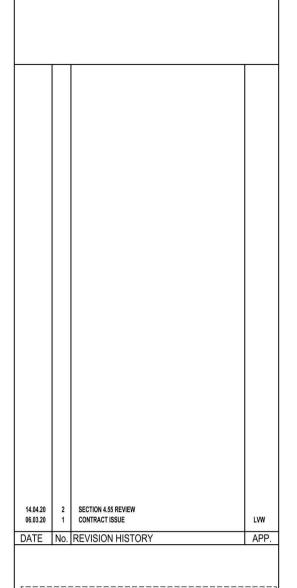

**KEY PLAN** 

principle consultant

aurecon

NEXTDC S3 Lot 6 219-247 Pacific Highway, Artarmon SYDNEY



NEXTDC GPO Box 3219 Brisbane QLD 4001 Land: 07 3177 4777 Email: Technical@nextdc.com Web: www.nextdc.com

CONTRACT ISSUE NOT FOR CONSTRUCTION

**CIVIL ENGINEERING SERVICES** STORMWATER
LONGITUDINAL SECTION

	LONGITUDINAL SECTION			
nm				
	project no: 503243	scale:		A1
1	drawn:	designed:		
	P.LE	T.HOANG		
	checked:	approved:		
	L.VAN WYK	L.VAN WYK		
	dwg no		rev	1
	S3-FAC-CI-DRG-00-401			